TOWN OF GARRETT PARK

SAFE ROUTES TO SCHOOL SIDEWALK (SRTS) PROJECT TOWN OF GARRETT PARK, MARYLAND

DESIGN CERTIFICATION

I HEREBY CERTIFY THAT THIS PLAN HAS BEEN PREPARED IN ACCORDANCE WITH THE "2011 MARYLAND STANDARDS AND SPECIFICATION FOR SOIL EROSION AND SEDIMENT CONTROL," MONTGOMERY COUNTY DEPARTMENT OF PERMITTING SERVICES EXECUTIVE REGULATIONS 5-90, 7-02AM AND 36-90, AND MONTGOMERY COUNTY DEPARTMENT OF PUBLIC WORKS AND TRANSPORTATION "STORM DRAIN DESIGN CRITERIA" DATED AUGUST 1988.

Design Engineer

Signature Date

Printed Name

Registration Number

CERTIFICATION OF THE QUANTITIES

I HEREBY CERTIFY THAT THE ESTIMATED TOTAL AMOUNT OF EXCAVATION AND FILL AS SHOWN ON THESE PLANS HAS BEEN COMPUTED TO 500.0 CUBIC YARDS OF EXCAVATION, 500.0 CUBIC YARDS OF FILL AND THE TOTAL AREA TO BE DISTURBED AS SHOWN ON THESE PLANS HAS BEEN DETERMINED TO BE 49,565 SQUARE FEET.

Signature

Printed Name and Title

OWNER'S/DEVELOPER'S CERTIFICATION

I/WE HEREBY CERTIFY THAT ALL CLEARING, GRADING, CONSTRUCTION, AND OR DEVELOPMENT WILL BE DONE PURSUANT TO THIS PLAN AND THAT ANY RESPONSIBLE PERSONNEL INVOLVED IN THE CONSTRUCTION PROJECT WILL HAVE A CERTIFICATE OF ATTENDANCE AT A DEPARTMENT OF NATURAL RESOURCES APPROVED TRAINING PROGRAM FOR THE CONTROL OF SEDIMENT AND EROSION BEFORE

Signature

TECHNICAL REVIEW OF

SEDIMENT CONTROL

Printed Name and Title

RECORD DRAWING CERTIFICATION A record set of approved Sediment Control/Stormwater Management plans must be maintained on-site at all times. In addition to stormwater management items, these plans must include the number and location of all trees proposed to be planted to comply with the Tree Canopy Law. Any approved modifications or deletions of stormwater practices or tree canopy plantings or information must be shown on this record set of plans and on the Tree Canopy Requirements table. Upon completion the project, this record set of plans, including hereon this signed Record Drawing Certification, must be submitted to the MCDPS inspector. In addition to this Record Drawing Certification, a formal Stormwater Management As-Built submission [] is required [] is not required for this project.

If this project is subject to a Stormwater Management Right of Entry and Maintenance Agreement, that document is recorded in Montgomery County Land _. This Record Drawing will serve as referenced in the recorded document.

his record drawing accurately and completely represents the stormwater management practices and tree canopy plantings as they were constructed or planted. All

ADMINISTRATIVE REVIEW

FIELD CHECK OF RECORD DRAWING BY MCDPS INSPECTOR: INITIALS:

concentrate runoff onto any adjacent property withou that property owner's permission. It does not relieve the design engineer or other responsible person of professional liability or ethical responsibility for the adequacy of the drainage design as it affects uphill or downhill properties. REVIEWED TECHNICAL REVIEW OF **SMALL LOT DRAINAGE APPROVAL** STORMWATER MANAGEMENT SEDIMENT **=** 283296 SEDIMENT CONTROL PERMIT NO. N/A: 🔲 OR STORMWATER - 282967 REVIEWED STORMWATER MANAGEMENT NOTE: MCDPS APPROVAL DOES NOT NEGATE THE NEED FOR A MCDPS ACCESS PERMIT. PROJECT HAS NOT STARTED. PROFESSIONAL CERTIFICATION: I CERTIFY THAT THESE DOCUMENTS WERE PREPARED OR APPROVED BY ME, AND THAT I AM A DULY LICENSED LAWS OF THE STATE OF MARYLAND.

DATE:


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LICENSE NO. <u>31168</u> EXPIRATION DATE: 1/12/2019

DPS approval of a sediment control or stormwater

minimum environmental runoff treatment standards

S.H.A. CONTRACT NO. XXXXXXXXX, F.A.P. NO. XXXXXXXXX

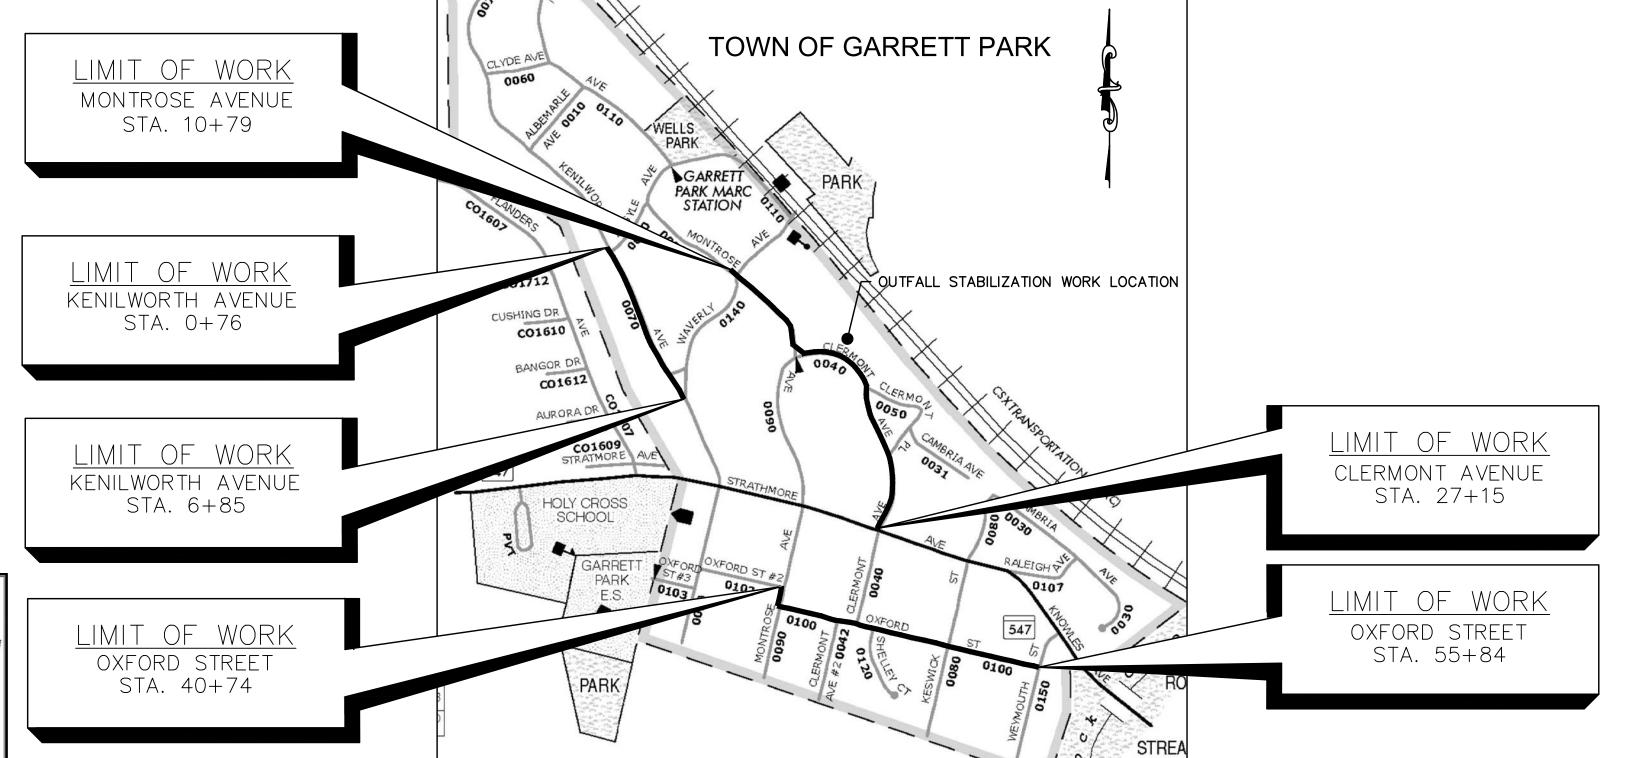

Montrose/Clermont Avenue = 0.31 MILES Kenilworth Avenue = 0.12 MILES SCALE: 1"=500' SCALE: 1"=500' HORIZONTAL DATUM NAD 83/91 NAVD 88 VERTICAL DATUM INDEX OF SHEETS

Length Of Project:

Oxford Street = 0.28 MILES

DRAWING NO. **DESCRIPTION** COVER GN-01 - GN-02GENERAL NOTES & TYPICAL DETAILS

LOCATION MAP

Town Of Garrett Park

SHEET NO.

2 - 3

TS-01 TYPICAL SECTIONS GEOMETRIC LAYOUT 5 – 6 GS-01 - GS-02 7 – 11 PS-01 - PS-05 SIDEWALK PLANS 12 - 13 SP-01 - SP-02 ADA ENLARGEMENTS 14 - 18 SC-01 - SC-05 EROSION & SEDIMENT CONTROL PLANS EROSION & SEDIMENT CONTROL DETAILS AND NOTES 19 - 20 SC-06 - SC-07 OUTFALL STABILIZATION PLAN AND DETAILS 21 – 23 0S-01 - 0S-03TREE PROTECTION PLANS 24 - 29 TP-01 - TP-06

AASHTO DESIGN CRITERIA

THIS PROJECT WAS DESIGNED IN ACCORDANCE WITH THE 2001 PUBLICATION OF AASHTO'S "A POLICY ON GEOMETRIC DESIGN OF HIGHWAYS AND STREETS."

STANDARD SPECIFICATIONS BOOK, BOOK OF STANDARDS AND MUTCD ALL WORK ON THIS PROJECT SHALL CONFORM TO: THE MARYLAND DEPARTMENT OF TRANSPORTATION, STATE HIGHWAY ADMINISTRATION'S SPECIFICATIONS ENTITLED STANDARD SPECIFICATIONS FOR CONSTRUCTION AND MATERIALS DATED JUNE 2017 REVISIONS THEREOF OR ADDITIONS THERETO; THE SPECIAL PROVISIONS INCLUDED IN THE INVITATION FOR BIDS BOOK; THE ADMINISTRATIONS BOOK OF STANDARDS FOR HIGHWAYS AND INCIDENTAL STRUCTURES AND

THE LATEST MANUAL ON UNIFORM TRAFFIC CONTROL DEVICES (MUTCD)

RIGHT-OF-WAY AND EASEMENT LINES SHOWN ON THESE PLANS ARE FOR ASSISTANCE IN INTERPRETING THE PLANS. THEY ARE NOT OFFICIAL. FOR OFFICIAL FEE RIGHT-OF-WAY AND EASEMENT INFORMATION, SEE APPROPRIATE RIGHT-OF-WAY PLATS.

LIMITS OF DISTURBANCE

THE ENTIRE LIMITS OF DISTURBANCE IS WITHIN THE TOWN OF GARRETT PARK RIGHT-OF-WAY. NO OFFSITE GRADING WILL BE PERMITTED.

THE LOCATION OF UTILITIES SHOWN ON THE PLANS ARE FOR INFORMATION AND GUIDANCE ONLY. NO GUARANTEE IS MADE OF THE ACCURACY OF SAID LOCATIONS.

ENVIRONMENTAL INFORMATION

PRD # PENDING COMPLETENESS OF DOCUMENTS

THE TOWN OF GARRETT PARK SHALL ONLY BE RESPONSIBLE FOR THE COMPLETENESS OF DOCUMENTS OBTAINED DIRECTLY FROM THE TOWN OF GARRETT PARK. FAILURE TO ATTACH ADDENDA MAY CAUSE THE BID TO BE IRREGULAR.

THE DESIGN OF THIS PROJECT HAS INCORPORATED FACILITIES FOR THE ELDERLY AND HANDICAPPED IN COMPLIANCE WITH THE STATE AND FEDERAL LEGISLATION.

EROSION AND SEDIMENT CONTROL

EROSION AND SEDIMENT CONTROL SHALL BE STRICTLY ENFORCED.

STANDARD STABILIZATION NOTE:

"FOLLOWING INITIAL SOIL DISTURBANCE OR REDISTURBANCE, PERMANENT OR TEMPORARY STABILIZATION SHALL BE COMPLETED WITHIN SEVEN (7) CALENDER DAYS AS TO THE SURFACE OF ALL PERIMETER CONTROLS, DIKES, SWALES, DITCHES, PERIMETER SLOPES, AND ALL SLOPES GREATER THAN 3 HORIZONTAL TO 1 VERTICAL (3:1), AND FOURTEEN DAYS (14) AS TO ALL OTHER DISTURBED OR GRADED AREAS ON THE PROJECT SITE."

STAGING AREA/STOCKPILE NOTE:

STAGING AND STORAGE OF ALL MATERIALS, EQUIPMENT, AND WASTE SHALL NOT BE ALLOWED OUTSIDE OF THE LIMITS OF DISTURBANCE AT ALL TIMES THROUGHOUT THE DURATION OF THE

ESC/SWM SHEET 1 OF 11

		To be completed by the consult	ant and placed	RELATEI on the first shee	D REQUIRED Plet of the Sediment Control /	ERMITS Sormwater Management plan	set for all projects.
To be completed by the consultant and placed on the first					•	OF THIS SITE TO OBTAIN PROVED SEDIMENT CON	
Exempt: Yes No X If exempt under applicable exemption category below.	all projects. Section 55-5 of the Code, please check the	TYPE OF PERMIT	REQD	NOT REQD	PERMIT#	EXPIRATION DATE	WORK RESTRICTION DATES
Total Property Area _50,227 square feet	Total Disturbed Area _50,227 _ square feet	MCDPS Floodplain District		$ \times $			
		WATERWAYS/WETLAND(S):		X			
Shade Trees Required 19	Shade Trees Proposed to be Planted 19	a. Corps of Engineers		×			
		b. MDE		X			
Fee in Lieu (Trees Required – Trees Planted) x \$250	<u> </u>	c. MDE Water Quality Certification		X			
Required Number Area (sq. ft.) of the Limits of Disturbance	er of Shade Trees Number of Shade Trees Required	MDE Dam Safety		X			
FROM TO 6,000 6,001 8,000 8,001 12,000	3 6 9	* DPS Roadside Trees Protection Plan	×			Approval Date	
12,001 14,000 14,001 40,000 If the square footage of the limits of dinumber of shade trees required must be considered to the square of the square footage of the limits of dinumber of shade trees required must be considered to the square of	12 15 isturbance is more than 40,000, then the alculated using the following formula:	N.P.D.E.S. NOTICE OF INTENT	×				DATE FILED
(Number of Square Feet in Limits of Disturbance ÷ 40,000) × 15 EXEMPTION CATEGORIES:		FEMA LOMR (Required Post Construction)		×			
55-5(a) any activity that is subject to Article II of Chapter 22A;	maintenance has obtained all required permits; 55-5(h) any stream restoration project if the	OTHERS (Please List):	X				
□ 55-5(b) any commercial logging or timber harvesting operation with an approved exemption from Article II of Chapter 22A; □ 55-5(f) any activity conducted by the County Parks	person performing the work has obtained all necessary permits; 55-5(i) cutting or clearing any tree to comply with	FOREST CONSERVATION EXEMPTION	X		42017136E 42017137E	Approval Date June 15, 2017	
Department; 55-5(g) routine or emergency maintenance of an existing access road, if the person performing the 95-5(g) routine or emergency maintenance of an existing access road, if the person performing the applicable provisions of any federal, state, or local law governing safety of dams; OTHER: Specify per Section 55-5 of the Code.		* A copy of the appro inspector at the pr				be delivered to the sed	iment control

ILE: J: \91140.04 - Safe Routes to School Sidewalks\CAD\dwg\COVER SHEET.dwg

GENERAL NOTES:


- THE CONTRACTOR SHALL CHECK ALL DIMENSIONS AND ELEVATIONS PRIOR TO CONSTRUCTION. ANY CONFLICTS CONCERNING THE CONSTRUCTION AROUND EXISTING OBSTRUCTIONS PER THESE PLANS SHALL BE RESOLVED BETWEEN THE CONTRACTOR AND THE FIELD ENGINEER.
- 2. THE CONTRACTOR AND OTHERS SHALL PERFORM ALL WORK IN A MANNER THAT WILL ENSURE THE LEAST PRACTICAL OBSTRUCTION TO TRAFFIC, PEDESTRIANS, RESIDENTS, AND BE CONSISTENT WITH SAFETY.
- BASELINE SHOWN FOR ILLUSTRATIVE PURPOSES ONLY. DIMENSIONS AND STATIONING ARE APPROXIMATE AND NOT A RESULT OF FIELD SURVEY.
- THE CONTRACTOR WILL NOTIFY PROPERTY OWNERS 72 HOURS PRIOR TO RECONSTRUCTION OF DRIVEWAY ENTRANCES.
- 5. THE STATE HIGHWAY ADMINISTRATION OR THE TOWN OF GARRETT PARK DOES NOT WARRANT THE CORRECTNESS OF THE TOPOGRAPHIC OR UTILITY DATA PRESENTED HEREIN AND IS NOT RESPONSIBLE FOR ANY CONCLUSIONS DRAWN FROM THEM.
- 6. SIDEWALK RECONSTRUCTION LIMITS SHALL COINCIDE WITH CRACK CONTROL JOINTS (JOINTER GROOVES) OR EXPANSION JOINTS IN EXISTING SIDEWALK. NEW EXPANSION JOINTS SHALL BE PROVIDED AT THE INTERFACE OF EXISTING AND PROPOSED SIDEWALK. SEE STANDARD MD. NO. 655.01.
- CONTRACTOR TO INSTALL DETECTABLE WARNING SURFACE ON ALL ADA CROSSWALK RAMPS AS PER STANDARD MD. NO. 655.40.
- 8. FORM NEW SIDEWALK AND EXPANSION JOINT MATERIAL AROUND EX. UTILITY POLES, MANHOLE COVERS, VALVE COVERS, AND FIRE HYDRANTS AS NECESSARY.
- 9. EXISTING INLETS SHALL NOT BE DAMAGED DURING CONSTRUCTION. DAMAGE TO THE INLETS WILL REQUIRE THE INLET TO BE REPLACED AT NO ADDITIONAL COST TO THE
- 10. RECONSTRUCT PROPERTY WALKWAYS TO TIE INTO PROPOSED SIDEWALK GRADES AS DIRECTED BY THE ENGINEER.
- 11. EXISTING CURB HEIGHTS PROVIDED ON PLAN SHALL BE VERIFIED BY THE CONTRACTOR. RAMP AND DRIVEWAY TRANSITION LENGTHS SHALL BE VERIFIED IN THE FIELD ACCORDING TO SHA STANDARD MD. NO. 630.01, MD. NO. 630.02, MD. NO. 655.11, MD. NO. 655.12, AND MD. NO. 655.13.
- 12. STABILIZE ALL DISTURBED AREAS NOT DRAINING TO A SEDIMENT CONTROL DEVICE AT THE END OF EACH DAY. THE CONTRACTOR SHALL LIMIT WORK ACTIVITIES SUCH THAT ALL DISTURBED AREAS CAN BE STABILIZED TO FINAL GRADE AND PLACEMENT OF THE TOP SOIL, SEED AND MULCH, SOD OR OTHER STABILIZATION METHODS CAN BE PERFORMED AT THE END OF
- 13. MAINTAIN ALL VEHICLE ACCESS POINTS AT RESIDENTIAL DRIVEWAYS AND UNSIGNALIZED INTERSECTIONS.
- 14. MAINTAIN IN GOOD CONDITION ALL EXISTING TRAFFIC SIGNS. IF, IN THE OPINION OF THE ENGINEER, ANY SIGNS ARE DAMAGED BY THE CONTRACTOR'S OPERATION, THEY ARE TO BE REPLACED BY THE CONTRACTOR AT HIS EXPENSE.
- 15. THE CONTRACTOR SHALL ADJUST ALL EXISTING VISIBLE MANHOLES, VALVE BOXES, INLETS AND OTHER STRUCTURES, AS PER SPECIFICATION SECTION 504 AND 875.
- 16. DO NOT LEAVE A PAVEMENT DROP-OFF AT ANYTIME AFTER A WORK DAY IS
- 17. MAINTAIN THE LIMITS OF WORK WITHIN THE PROJECT IN A SAFE AND NEAT MANNER THROUGHOUT THE DURATION OF THE CONTRACT. PILES OF DEBRIS SUCH AS EXCAVATED SOIL AND HMA ARE EXPECTED TO BE REMOVED OR STABILIZED WITHIN THE SAME WORKING DAY. FAILURE TO COMPLY WITH THIS REQUIREMENT MAY RESULT IN ADMINISTRATIVE ACTION AS OUTLINED UNDER FAILURE TO MAINTAIN PROJECT OF THE SPECIFICATIONS.
- 18. ALL WORK WILL BE CONDUCTED IN TOWN OF GARRETT PARK RIGHT-OF-WAY AND THE CONTRACTOR MUST OBTAIN A RIGHT-OF-ENTRY AGREEMENT FROM THE TOWN OF GARRETT PARK PRIOR TO THE COMMENCEMENT OF ANY STAGING ACTIVITIES SUCH AS THE ESTABLISHMENT OF A FIELD OFFICE OR FOR THE STORAGE OF EQUIPMENT AND MATERIAL WITHIN SAID RIGHT-OF-WAY. APPROVAL WILL REQUIRE THE EXECUTION THE AGREEMENT AND A RETAINAGE TO BE WITHHELD FROM PROGRESS PAYMENTS UNTIL SUCH TIME THE AFFECTED AREA(S) HAVE BEEN RESTORED TO PRE-USE CONDITION. IF ADDITIONAL DISTURBANCE IS NECESSARY, THE CONTRACTOR MAY BE REQUIRED TO AMEND ANY APPLICABLE PERMITS THAT MAY BE AFFECTED AND WILL BE SUBJECTED TO ANY AND ALL PERMIT CONDITIONS.
- 19. REFER TO SHEETS SC-01 SC-07 FOR EROSION AND SEDIMENT CONTROL REQUIREMENTS.
- 20. SEDIMENT AND EROSION CONTROL REGULATIONS WILL BE STRICTLY ENFORCED DURING CONSTRUCTION.
- 21. SIDEWALK RAMP CONSTRUCTION WILL BE PAID AS 5 INCH CONCRETE SIDEWALK.
- 22. WHERE CURB, CURB AND GUTTER, OR DEPRESSED CURB IS PROPOSED, THE CONTRACTOR SHALL REPLACE THE ADJACENT CURB OR CURB AND GUTTER TO THE EXISTING CURB JOINT.
- 23. CONTRACTOR SHALL PROVIDE ENTRANCE TIE-IN AS NECESSARY TO PROVIDE ADEQUATE TRANSITION FROM RECONSTRUCTED ENTRANCE TO EXISTING PAVEMENT (SEE MD 630.01 AND MD 630.02); PAVEMENT MATERIAL SHALL MATCH EXISTING.
- 24. HMA FOR DRIVEWAYS WILL BE SUPERPAVE ASPHALT MIX 9.5MM FOR SURFACE, PG 64S-22, LEVEL 4 (2 INCH DEPTH).
- 25. ADJUST EXISTING UTILITIES IMPACTED BY THE SIDEWALK & SIDEWALK RAMP CONSTRUCTION.
- THE COST IS INCIDENTAL TO SIDEWALK AND SIDEWALK RAMP CONSTRUCTION. 26. THE CONTRACTOR SHALL RESET ANY SIGNS DISTURBED BY THE CONSTRUCTION AS
- DIRECTED BY THE ENGINEER. 27. ALL CONCRETE FOR CURBS, SIDEWALKS, DRIVEWAY APRONS, ETC. SHALL BE COLORED CONCRETE. COLOR SHALL BE INTEGRAL TO THE CONCRETE. THE TOWN SHALL SELECT A COLOR FROM A CHART OF STANDARD COLORS. CONTRACTOR SHALL PROVIDE COLOR SAMPLES TO TOWN. A 5' X 5' TEST PANEL SHALL BE PREPARED TO SHOW CONCRETE COLOR AND BE ACCEPTED BY THE TOWN PRIOR TO FINALIZING COLOR FOR THE ENTIRE

PROJECT. THE CONTRACTOR SHALL NOT CHANGE COLOR OR PIGMENT MANUFACTURER


- DURING CONSTRUCTION. IT IS THE INTENTION OF THE TOWN FOR THE CONCRETE TO BE TAUPE IN COLOR.
- MAINTENENCE OF TRAFFIC NOTES: 1. MD SHA STANDARD PLATES ARE TO BE USED FOR MAINTENENCE OF TRAFFIC.
- 2. ALL WORK SHALL BE PERFORMED IN ACCORDANCE WITH THE MOT STANDARDS MD 104.00-01 THRU 104.06-25.
- 3. NO WORK IS TO BEGIN UNTIL ALL ADVANCE WARNING SIGNS, DRUMS AND ARROW PANELS ARE IN PLACE AND OPERATIONAL.
- 4. ADVANCED NOTIFICATION OF SIDEWALK CLOSURES SHALL BE PROVIDED. A BARRIER THAT IS DECTECTABLE BY A PERSON WITH A VISUAL DISABILITY SHALL BE PLACED ACROSS THE FULL WIDTH OF THE CLOSED SIDEWALK.
- WHERE PEDESTRIANS ARE DIRECTED TO CROSS TO THE OPPOSIDE SIDE OF THE ROADWAY, APPROPRIATE ADVANCED WARNING SIGNS SHOULD BE PLACED AT THE INTERSECTIONS RATHER THAN MID-BLOCK CROSSINGS.
- 6. TRAFFIC CONTROL DEVICES AND OTHER CONSTRUCTION MATERIALS AND FEATURES SHALL NOT INTRUDE INTO THE USABLE WIDTH OF THE SIDEWALK, TEMPORARY OR



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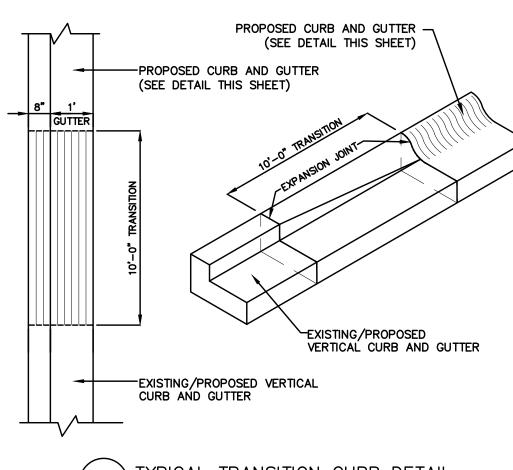


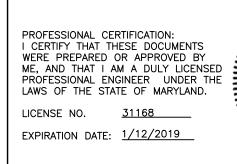

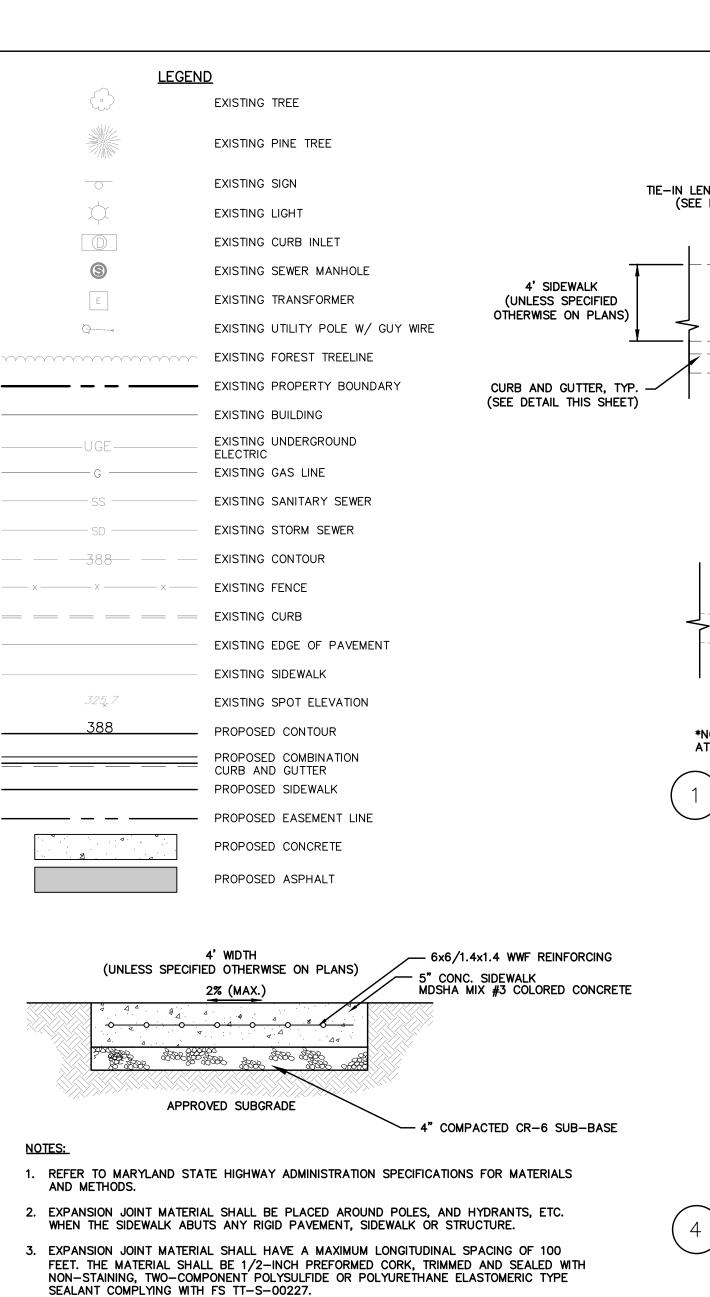


4. SCORE THE CONCRETE TO A DEPTH OF 1/3 THE SLAB THICKNESS TO PROVIDE WEAKENED PLANE TRAVERSE JOINTS AT 5'-0" INTERVALS, PARALLEL WITH AND PERPENDICULAR TO THE CURBING OR AS INDICATED ON THE SCORING PLAN.





TYPICAL TRANSITION CURB DETAIL

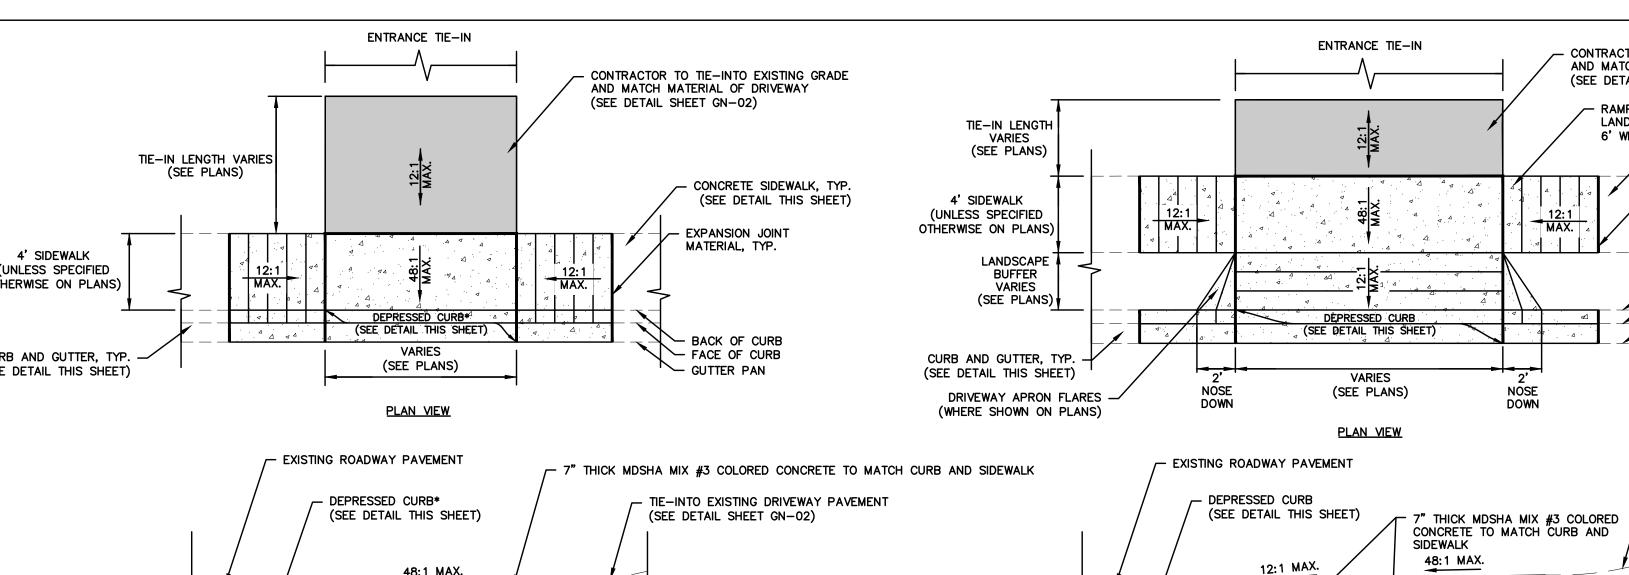

*NOTE: MOUNTABLE CURB TO BE USED AT DRIVEWAY ENTRANCES LOCATED AT 4402 & 4406 OXFORD STREET.

PROFILE VIEW

ADA COMPLIANT DRIVEWAY APRON

- FACE OF CURB LINE

- 8" COLORED CONCRETE

- FACE OF CURB LINE

TYPICAL DEPRESSED CURB DETAIL

TYPICAL COMBINATION VERTICAL

CURB AND GUTTER DETAIL

(COLOR TO BE SELECTED BY TOWN)

- 6" GRADED

AGGREGATE BASE


8" COLORED CONCRETE

- 6" GRADED AGGREGATE BASE

(COLOR TO BE SELECTED BY TOWN)

- 6" GRADED AGGREGATE BASE


TYPICAL DRIVEWAY APRON WITHOUT BUFFER

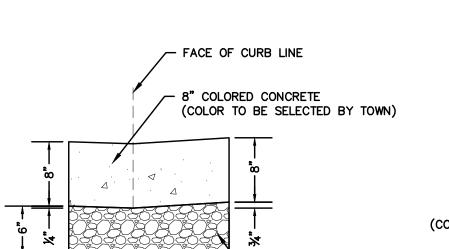

- 6" GRADED

FOR USE AT ADA RAMPS)

TYPICAL DEPRESSED CURB DETAIL

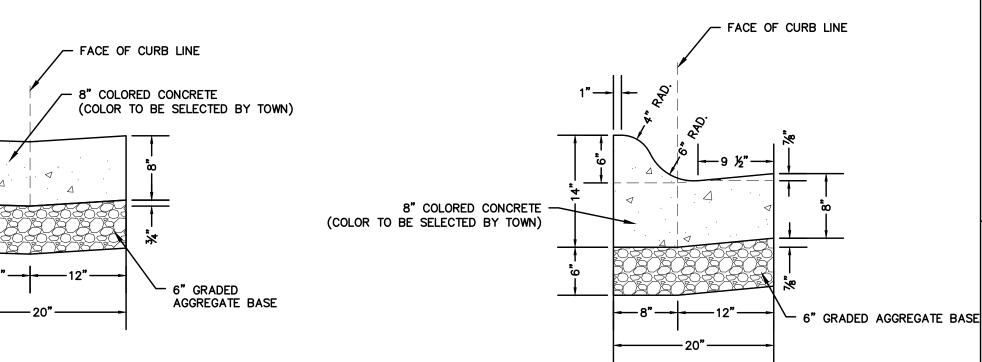

ADA COMPLIANT DRIVEWAY APRON

6" GRADED AGGREGATE BASE

TYPICAL COMBINATION ROLLED

CURB AND GUTTER DETAIL

PROFILE VIEW

TYPICAL DRIVEWAY APRON WITH BUFFER

CONTRACTOR TO TIE-INTO EXISTING GRADE

RAMP REQUIRED IN AREAS WHERE

LANDSCAPE BUFFER IS LESS THAN

- CONCRETE SIDEWALK, TYP

EXPANSION JOINT MATERIAL, TYP.

→ BACK OF CURB

FACE OF CURB

✓ GUTTER PAN

TIE-INTO EXISTING

DRIVEWAY PAVEMENT

(SEE DETAIL SHEET GN-02)

(SEE DETAIL THIS SHEET)

AND MATCH MATERIAL OF DRIVEWAY


(SEE DETAIL SHEET GN-02)

FACE OF CURB LINE 8" COLORED CONCRETE (COLOR TO BE SELECTED BY TOWN) 6" GRADED AGGREGATE BASE

TYPICAL MOUNTABLE CURB DETAIL

			TOWN OF GARRETT PARK
	DATUM:	NAD 83/91 Horizontal	PEDESTRIAN FACILITY DESIGN SERVICES
		NAVD 88 Vertical	SAFE ROUTES TO SCHOOL (SRTS)
CROSS REFERE	INCE	REVISIONS	GENERAL NOTES AND TYPICAL DETAILS
ITEM	SHEET NOs.		SCALE N.T.S. ADVERTISED DATE OCT. 2017 CONTRACT NO.
	1		

		NAVD 88 Vertical		SAFE ROUTES TO) SCHOOL	(SRTS)
CROSS REFERENCE		REVISIONS	GEN	IERAL NOTES AI	ND TYPI	CAL DETAILS
ITEM	SHEET NOs.		SCALE_N.T.S.	ADVERTISED DATE (OCT. 2017	CONTRACT NO. TBD
COVER GENERAL NOTES AND TYPICAL DETAILS TYPICAL SECTIONS GEOMETRIC LAYOUT SIDEWALK PLANS ADA ENLARGEMENTS EROSION & SEDIMENT CONTROL PLANS EROSION & SEDIMENT CONTROL DETAILS EROSION & SEDIMENT CONTROL NOTES OUTFALL STABILIZATION PLAN AND DETAILS	4 5 - 6 7 - 11 12 - 13 14 - 18 19 20		DRAWN BY	ME ME JA TBD	LOGMILE HORIZON	MONTGOMERY TAL SCALE L SCALE
TREE PROTECTION PLANS TREE PROTECTION DETAILS	24 - 28 29		DRAWING NO.	GN-01 O F	= 2	SHEET NO. 2 OF 29
		PLOTTED:3/6/2017 11:39 AM FILE:J:\91140.04 — Safe Routes to School DETAILS.dwg	ol Sidewalks\CAD\dwg`	\GN01-02 GENERAL NOTES	S AND	

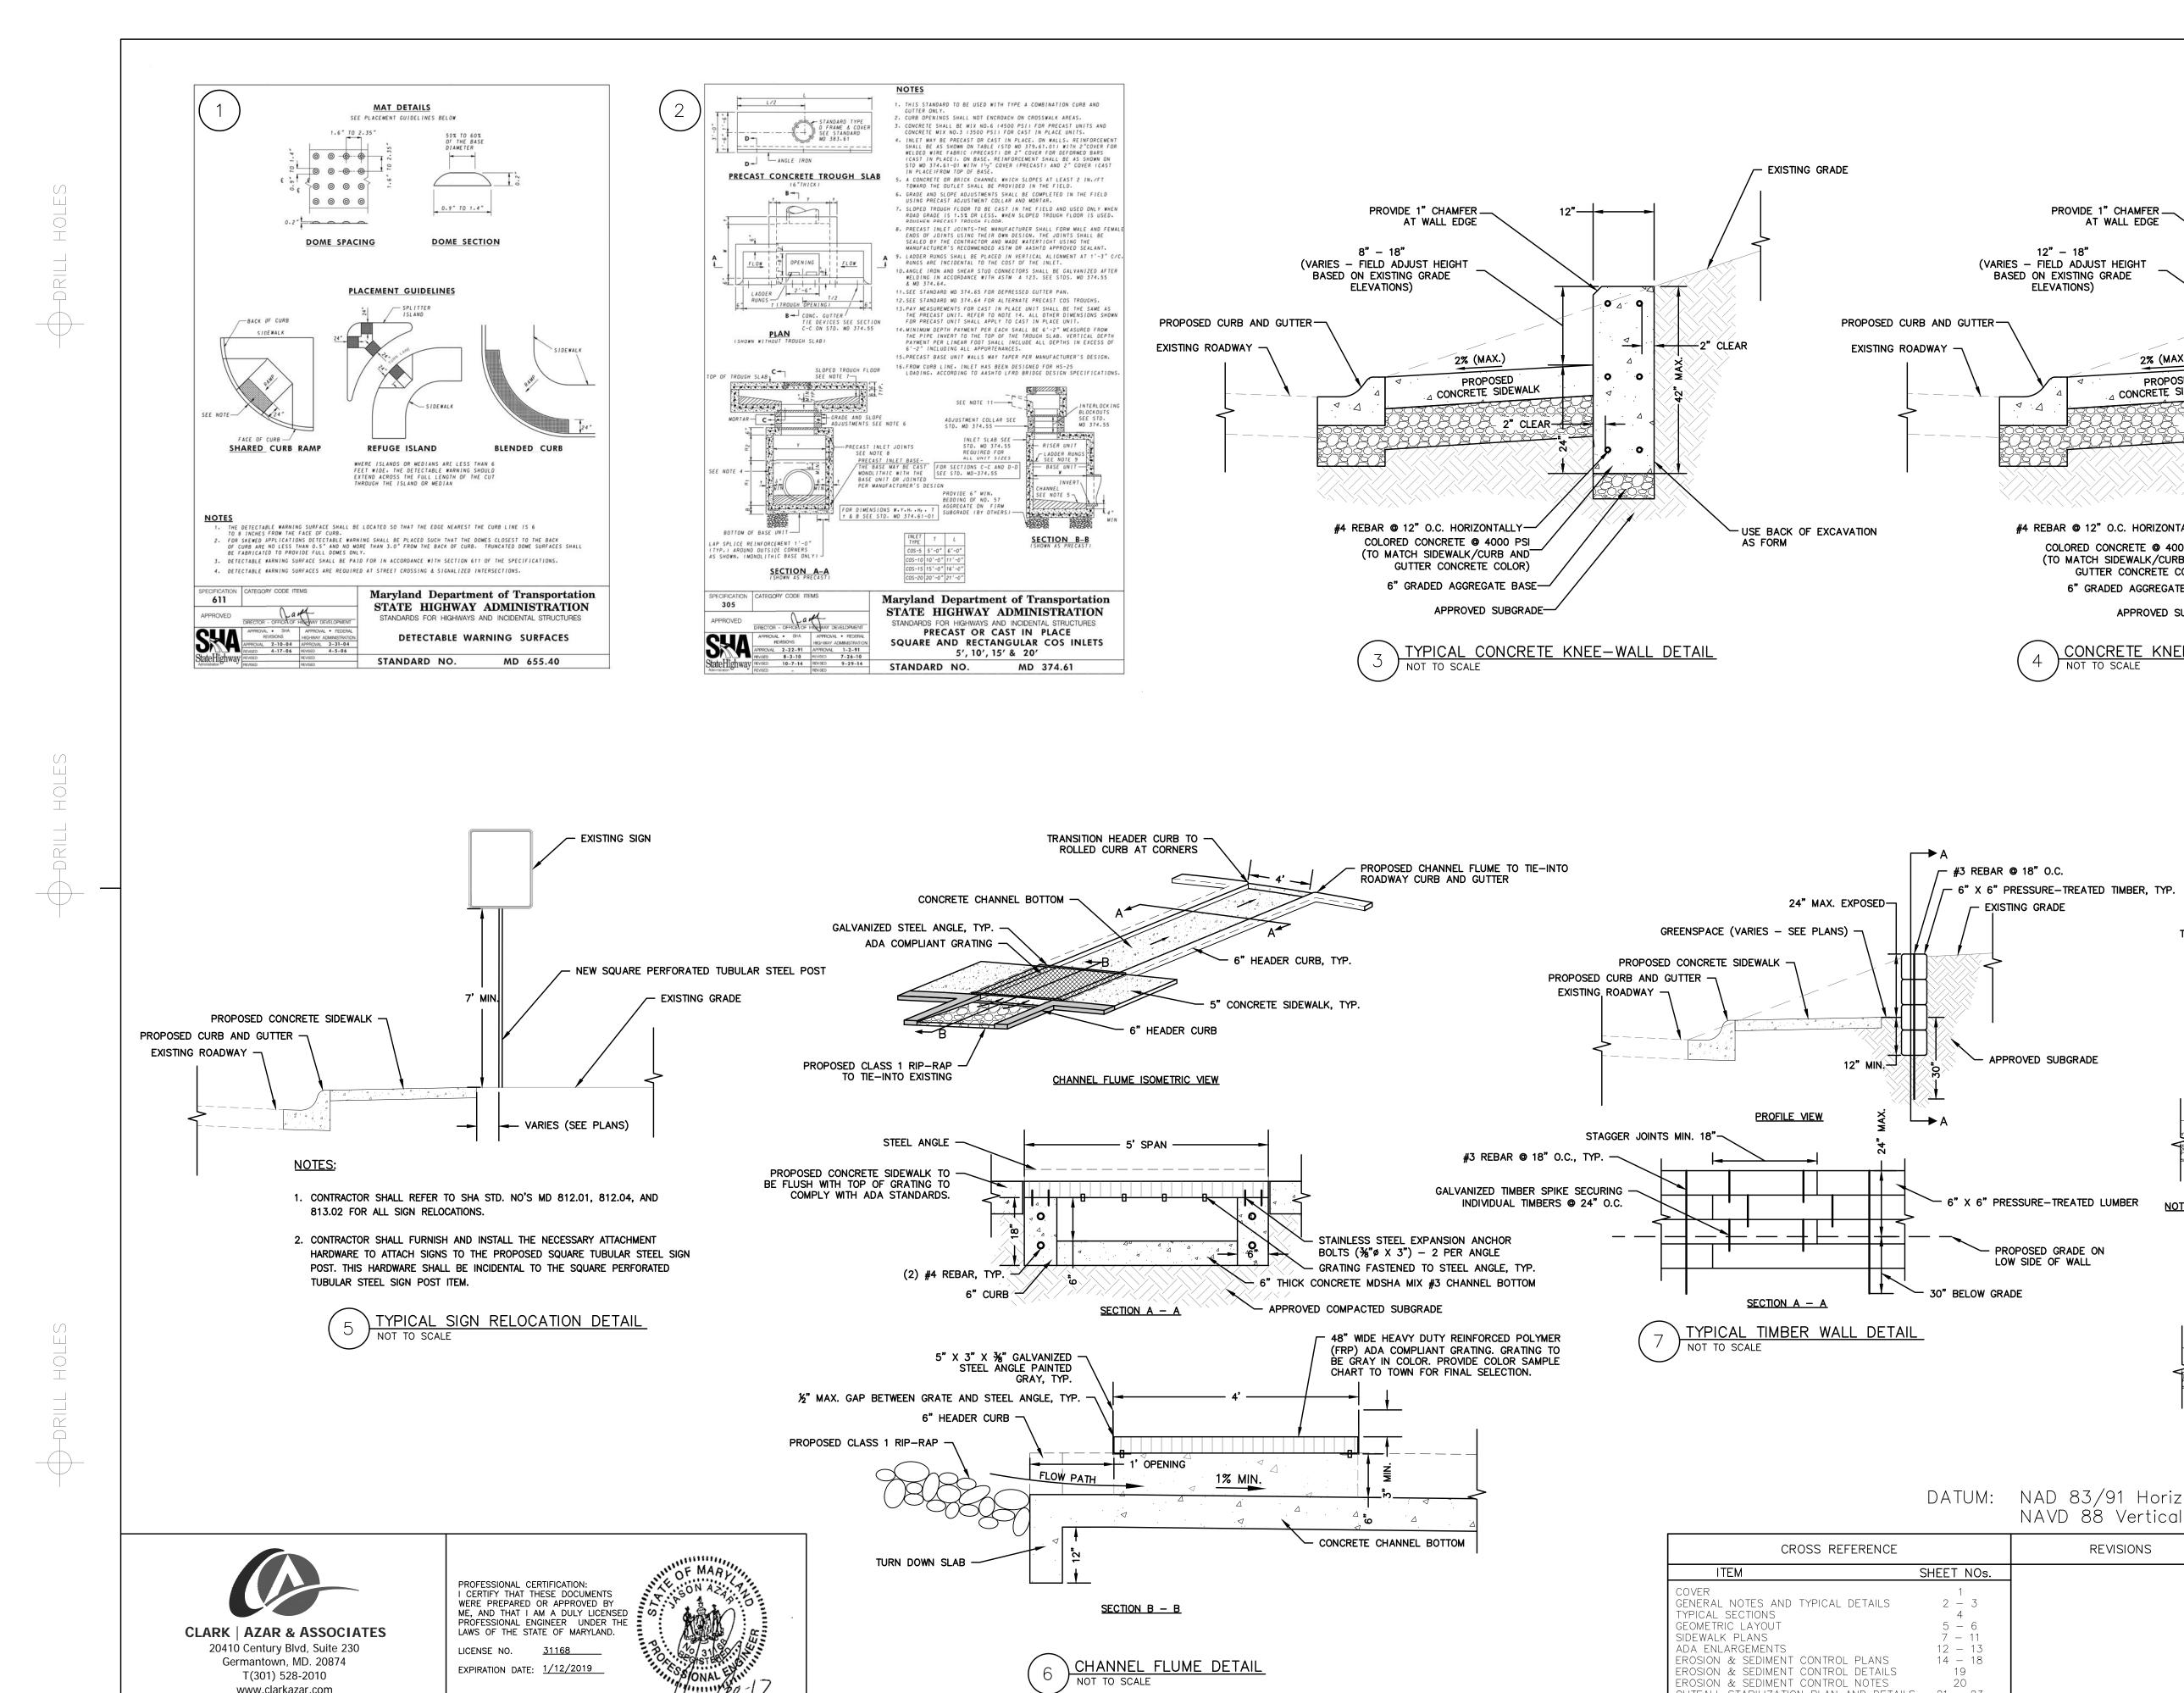


÷2" CLÉAR 2% (MAX.) △ CONCRETE SIDEWALK 2" CLEAR #4 REBAR @ 12" O.C. HORIZONTALLY-USE BACK OF EXCAVATION AS FORM COLORED CONCRETE @ 4000 PSI (TO MATCH SIDEWALK/CURB AND GUTTER CONCRETE COLOR) 6" GRADED AGGREGATE BASE— APPROVED SUBGRADE-CONCRETE KNEE-WALL DETAIL (AT UTILITY POLE LOCATION) — EXISTING ROADWAY SURFACE - PROPOSED SAWCUT LINE TO BE COORDINATED WITH STAKEOUT LOCATIONS OF PROPOSED FACE OF CURB ON PLANS / 2" 9.5 MM ASPHALT SUPERPAVE SURFACE COURSE - FACE OF CURB LINE - PROPOSED CURB AND GUTTER 6" GRADED TYPE 2 CONCRETE AGGREGATE BASE TYPICAL SAWCUT AND PAVEMENT PATCH DETAIL 7" TYPE 3 COLORED CONCRETE TO MATCH CURB AND SIDEWALK EXISTING ASPHALT DRIVEWAY PAVEMENT 48:1 MAX. ADA COMPLIANT DRIVEWAY APRON -DISTANCE VARIES - SEE PLANS SAWCUT EXISTING CONCRETE DRIVEWAY PAVEMENT - 6" GRADED AGGREGATE BASE NOTE: DRIVEWAY TIE-INS TO BE CONSTRUCTED USING CONCRETE AT THE FOLLOWING LOCATIONS:

• 10920 CLERMONT AVENUE • 10918 CLERMONT AVENUE 10916 CLERMONT AVENUE • 10715 CLERMONT AVENUE 4406 OXFORD STREET MINIMUM 2" MILL AND WEDGE OVERLAY WITH 9.5 MM ASPHALT SUPERPAVE - EXISTING ASPHALT DRIVEWAY PAVEMENT 48:1 MAX. ADA COMPLIANT DRIVEWAY APRON DISTANCE VARIES - SEE PLANS TYPICAL DRIVEWAY TIE-IN DETAILS TOWN OF GARRETT PARK DATUM: NAD 83/91 Horizontal PEDESTRIAN FACILITY DESIGN SERVICES NAVD 88 Vertical SAFE ROUTES TO SCHOOL (SRTS) GENERAL NOTES AND TYPICAL DETAILS SCALE N.T.S. ADVERTISED DATE OCT. 2017 CONTRACT NO. TBD DESIGNED BY _ COUNTY _____MONTGOMERY DRAWN BY _ LOGMILE CHECKED BY ____ HORIZONTAL SCALE F.A.P. NO. VERTICAL SCALE www.clarkazar.com OUTFALL STABILIZATION PLAN AND DETAILS 21 - 23 A Woman Owned Small Business TREE PROTECTION PLANS 24 – 28 SHEET NO. 3 OF 29 DRAWING NO. GN-02 **OF** TREE PROTECTION DETAILS ILE: J: \91140.04 - Safe Routes to School Sidewalks\CAD\dwg\GN01-02 GENERAL NOTES AND DETAILS.dwg


-EXISTING UTILITY POLE


- EXISTING GRADE



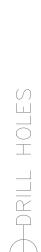




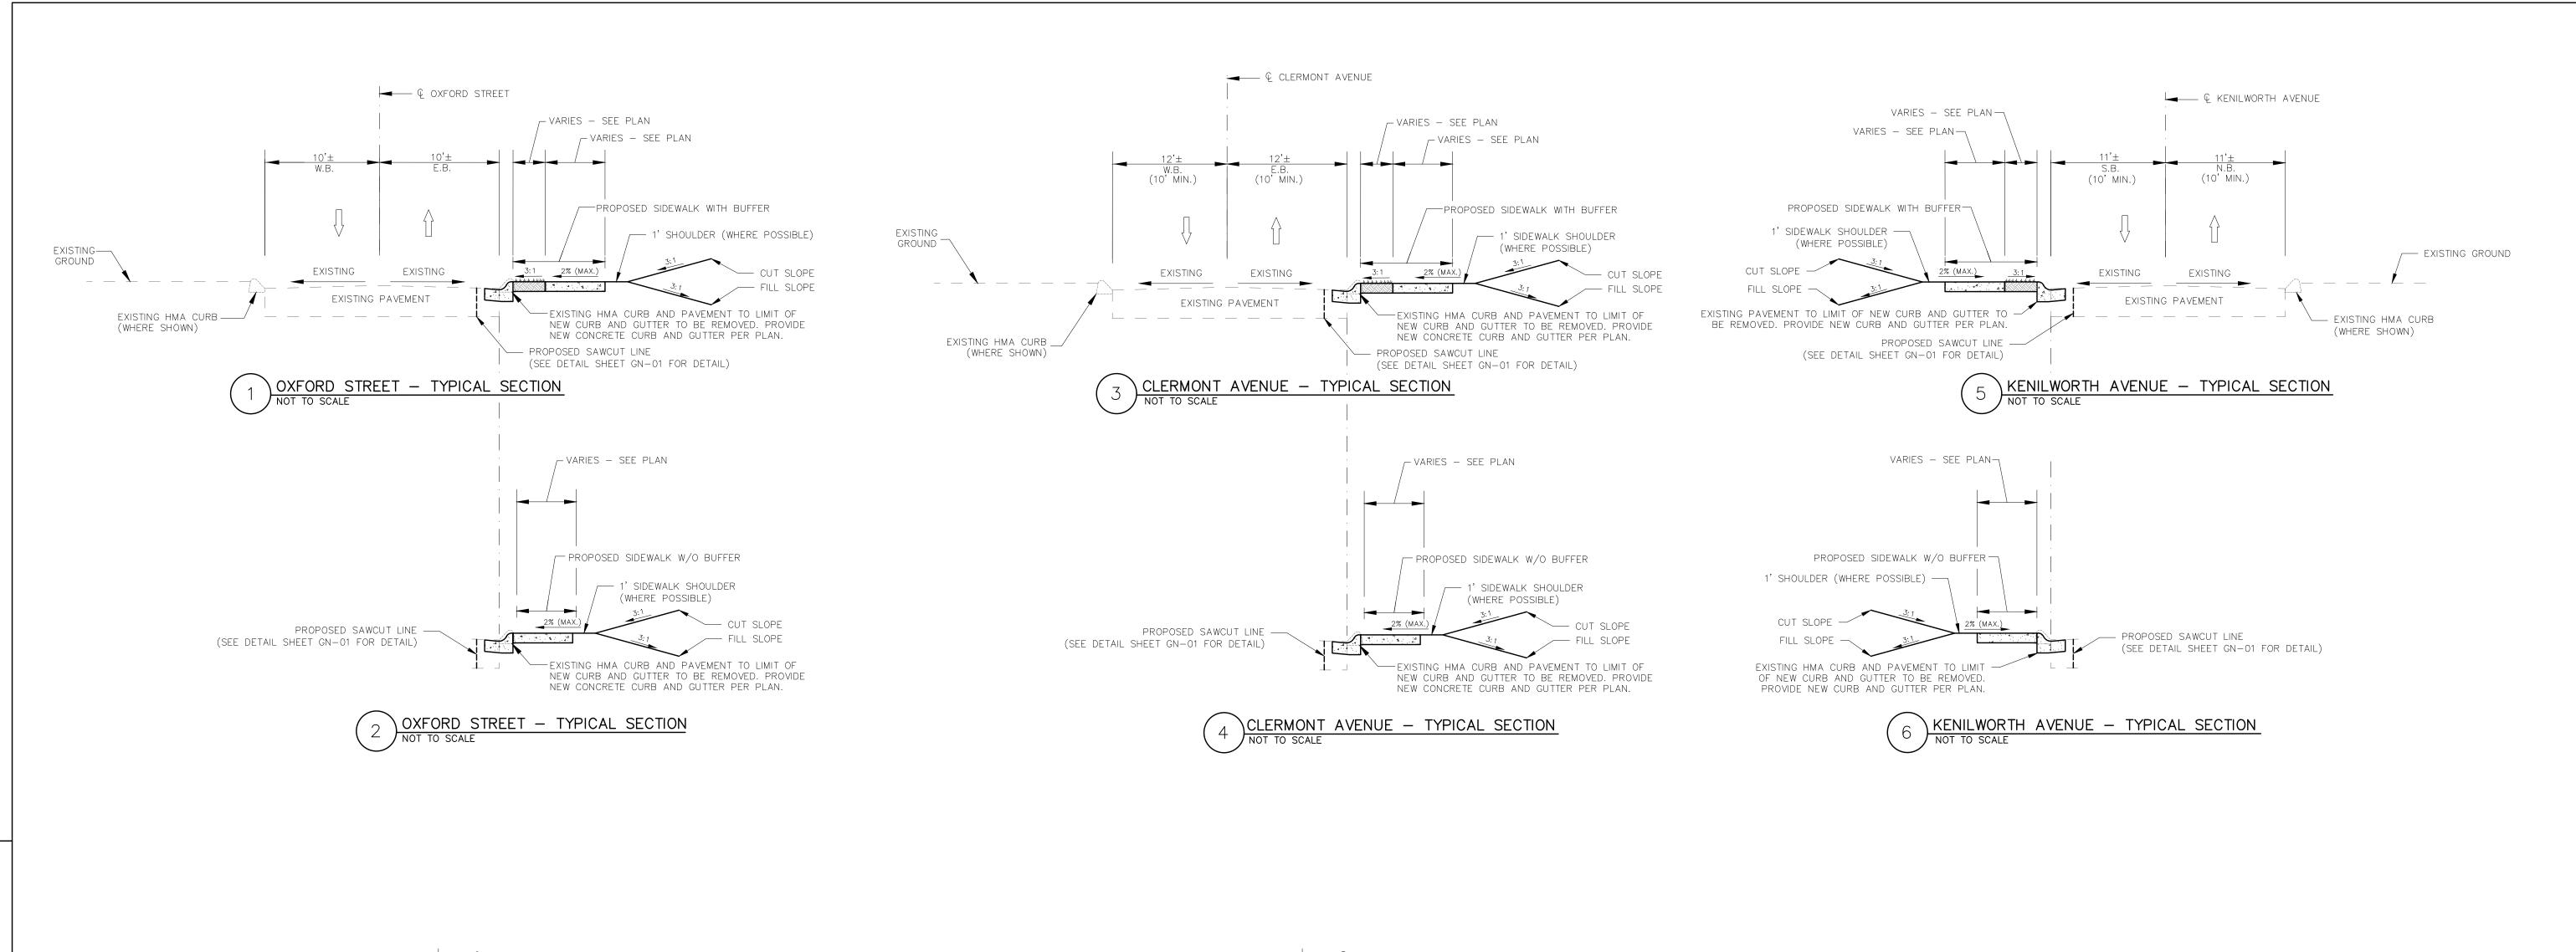

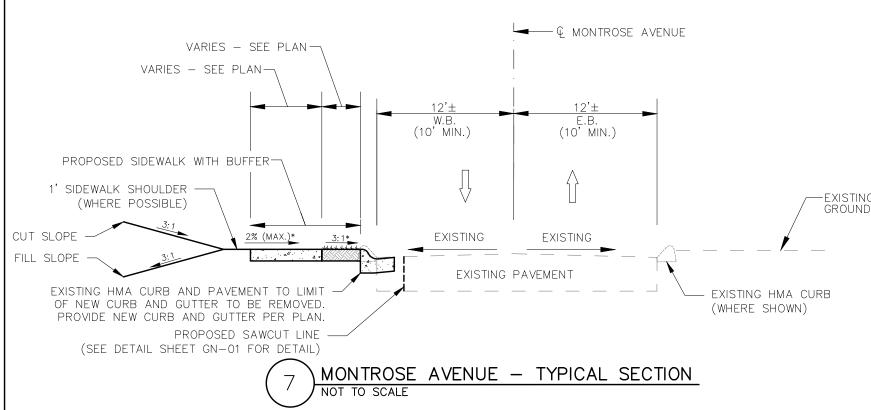

*NOTE: PROPOSED GREENSPACE AND SIDEWALK TO BE PITCHED AWAY FROM ROADWAY IN SPECIFIED AREA ALONG MONTROSE AVENUE — SEE PLANS FOR LOCATION. (STA. 15+00 TO STA. 15+97)

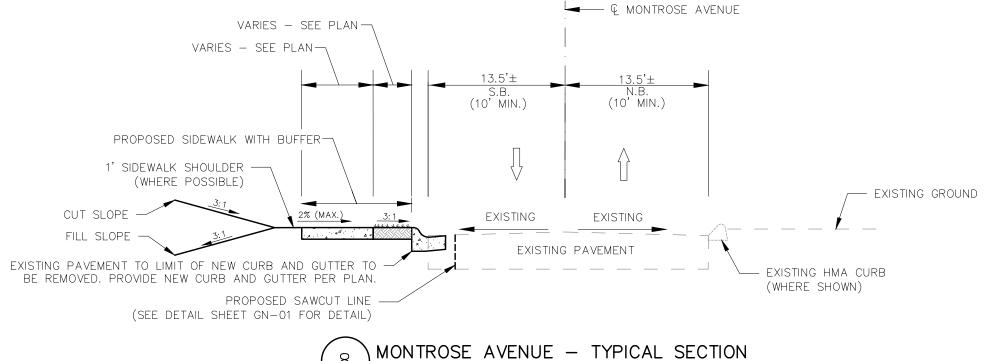

GENERAL NOTE:

LOCATION OF PROPOSED CURB AND GUTTER AND SAWCUT LINE ARE FOR ILLUSTRATIVE PURPOSES ONLY. REFER TO SAWCUT/PAVEMENT REMOVAL DETAIL ON SHEET GN-02 FOR FURTHER INFORMATION.

CLARK | AZAR & ASSOCIATES
20410 Century Blvd, Suite 230

Germantown, MD. 20874

T(301) 528-2010 www.clarkazar.com A Woman Owned Small Business PROFESSIONAL CERTIFICATION:
I CERTIFY THAT THESE DOCUMENTS
WERE PREPARED OR APPROVED BY
ME, AND THAT I AM A DULY LICENSED
PROFESSIONAL ENGINEER UNDER THE
LAWS OF THE STATE OF MARYLAND.

LICENSE NO. 31168


EXPIRATION DATE: 1/12/2019

DATUM: NAD 83/91 Horizontal NAVD 88 Vertical TOWN OF GARRETT PARK

PEDESTRIAN FACILITY DESIGN SERVICES

SAFE ROUTES TO SCHOOL (SRTS)

CROSS REFERENCE		REVISIONS	TYPICAL SECTIONS
	SHEET NOs.		SCALE N.T.S. ADVERTISED DATE OCT. 2017 CONTRACT NO. TBD
TYPICAL SECTIONS GEOMETRIC LAYOUT SIDEWALK PLANS ADA ENLARGEMENTS EROSION & SEDIMENT CONTROL PLANS	2 - 3 4 5 - 6 7 - 11 12 - 13 14 - 18 19 20 21 - 23		DESIGNED BY ME COUNTY MONTGOMERY DRAWN BY ME LOGMILE HORIZONTAL SCALE VERTICAL SCALE F.A.P. NO. TBD VERTICAL SCALE
TREE PROTECTION PLANS TREE PROTECTION DETAILS	24 - 28 29		DRAWING NO. TS-01 OF 1 SHEET NO. 4 OF 29
		PLOTTED:3/6/2017 11:39 AM FILE:J:\91140.04 — Safe Routes to School	ool Sidewalks\CAD\dwg\TS01 TYPICAL SECTIONS.dwg

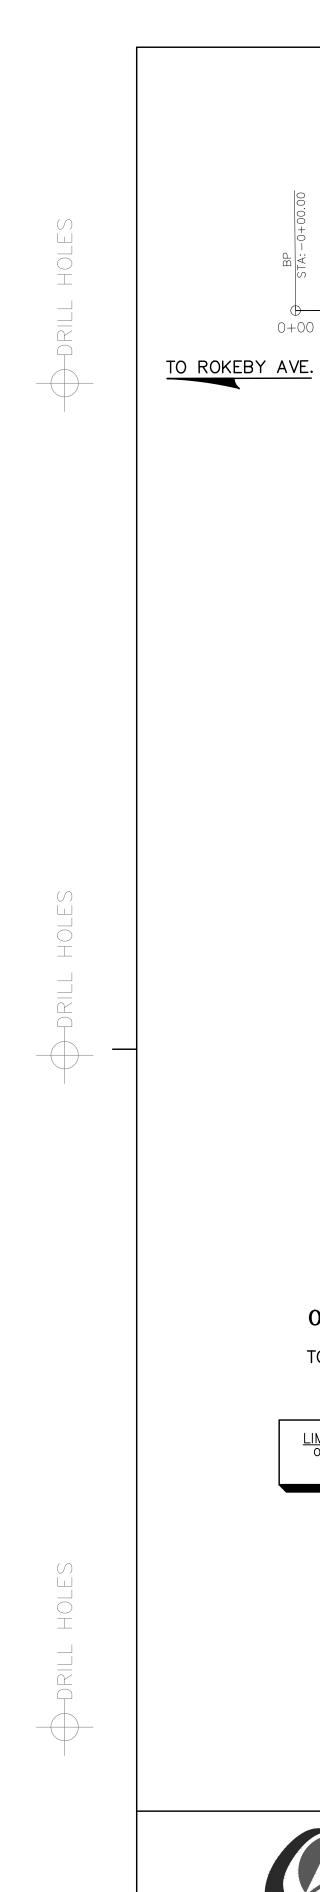

LIMIT OF WORK KENILWORTH AVENUE STA. 0+76

₽ - BASELINE OF CONSTRUCTION -

PROFESSIONAL CERTIFICATION:
I CERTIFY THAT THESE DOCUMENTS
WERE PREPARED OR APPROVED BY
ME, AND THAT I AM A DULY LICENSED
PROFESSIONAL ENGINEER UNDER THE
LAWS OF THE STATE OF MARYLAND.

LICENSE NO. 31168


EXPIRATION DATE: 1/12/2019

CLARK | AZAR & ASSOCIATES 20410 Century Blvd, Suite 230 Germantown, MD. 20874

T(301) 528-2010 www.clarkazar.com A Woman Owned Small Business KENILWORTH AVENUE

GEOMETRIC LAYOUT STA. 0+00 - STA. 7+06 LIMIT OF WORK KENILWORTH AVENUE STA. 6+85

TO MD 547

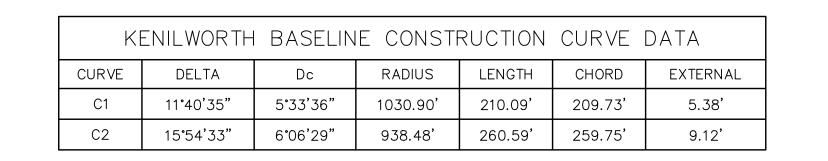


	ŀ	KENILWORTH	H BASELINE CONSTRUCTION	ON LINE DATA
LINE	LENGTH	BEARING	START POINT (NORTHING, EASTING)	END POINT (NORTHING, EASTING)
L1	235.18'	S21° 00' 30"E	(1285019.8398,499243.1051)	(1285104.1529,499023.5589)

OXFORD WEST BASELINE CONSTRUCTION CURVE DATA								
CURVE	DELTA	Dc	RADIUS	LENGTH	CHORD	EXTERNAL		
C15	1°37'12"	3°49'32"	1498.00'	42.35'	42.35'	0.15'		

	OXFORD WEST BASELINE CONSTRUCTION LINE DATA							
LINE	LENGTH	BEARING	START POINT (NORTHING, EASTING)	END POINT (NORTHING, EASTING)				
L8	20.60'	S77° 57' 03"E	(1285691.9100,497743.1216)	(1285712.0585,497738.8208)				
L9	65.04	S76° 19' 51"E	(1285753.3482,497729.3951)	(1285816.5502,497714.0242)				

MONTROSE BASELINE CONSTRUCTION LINE DATA						
LINE	LENGTH	BEARING	START POINT (NORTHING, EASTING)	END POINT (NORTHING, EASTING)		
L7	299.99'	S12° 47' 38"W	(1285831.7667,497837.0972)	(1285765.3354,497544.5520)		

	0	XFORD EAS	T BASELINE CONSTRUCTION	ON LINE DATA
LINE	LENGTH	BEARING	START POINT (NORTHING, EASTING)	END POINT (NORTHING, EASTING)
L10	1412.65	S76° 38' 55"E	(1285768.3312,497618.8328)	(1287142.8050,497292.6204)

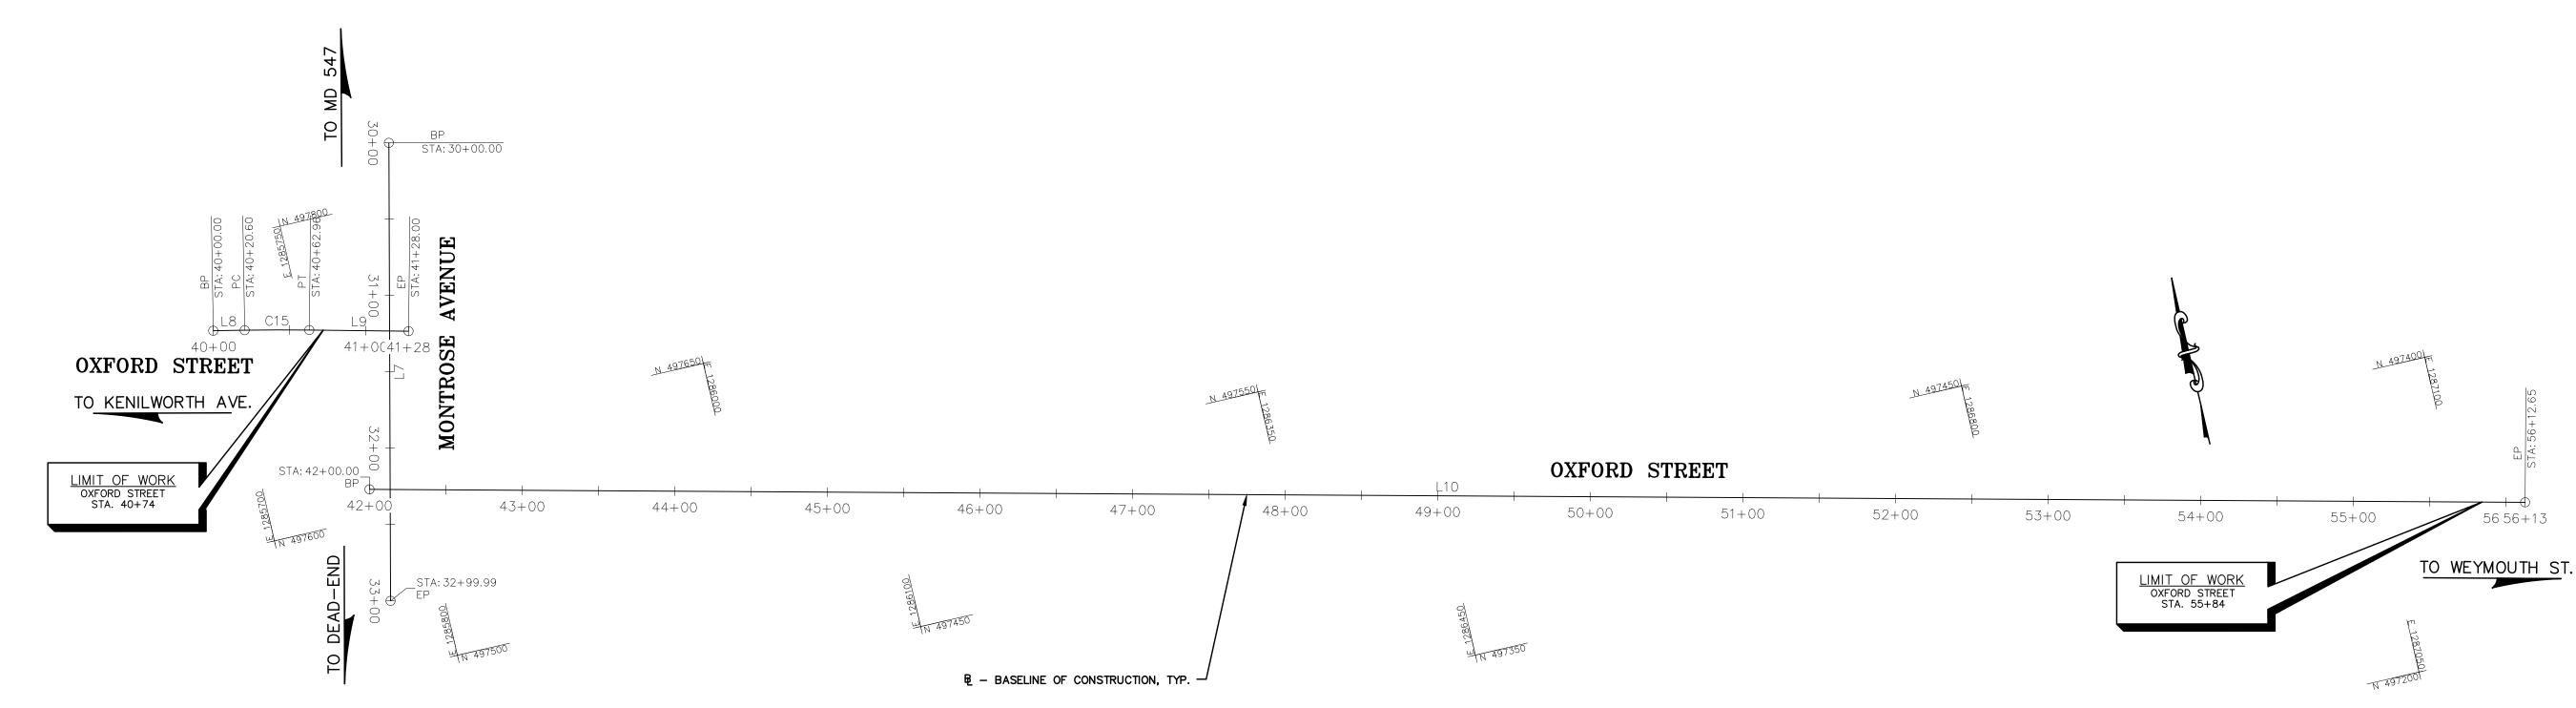

GEOMETRIC LAYOUT

OXFORD STREET WEST: STA. 40+00 - STA. 41+28

MONTROSE STREET: STA. 30+00 - STA. 33+00

OXFORD STREET EAST: STA. 42+00 - STA. 56+13

DATUM: NAD 83/91 Horizontal NAVD 88 Vertical TOWN OF GARRETT PARK

PEDESTRIAN FACILITY DESIGN SERVICES

SAFE ROUTES TO SCHOOL (SRTS)

GRAPHIC SCALE 60 0 30 60 120 240 ADA ENLA EROSION EROSION EROSION OUTFALL TREE PRO		IT
	60 0 30 60 120 240 (IN FEET)	GENERAL TYPICAL: GEOMETRI SIDEWALK ADA ENLA EROSION EROSION EROSION

CROSS REFERENCE		REVISIONS		GEOMETRI	C LAYC	DUT	
ITEM	SHEET NOs.		SCALE <u>1" = 60'</u> AI	DVERTISED DATE <u>OC</u>	CT. 2017	CONTRACT NO	TBD
R RAL NOTES AND TYPICAL DETAILS AL SECTIONS ETRIC LAYOUT /ALK PLANS ENLARGEMENTS ON & SEDIMENT CONTROL PLANS ON & SEDIMENT CONTROL DETAILS ON & SEDIMENT CONTROL NOTES ALL STABILIZATION PLAN AND DETAILS	4 5 - 6 7 - 11 12 - 13 14 - 18 19 20		DESIGNED BY DRAWN BY CHECKED BY F.A.P. NO	ME JA	LOGMILE HORIZON	MONTGOMERY ITAL SCALE L SCALE	
PROTECTION PLANS PROTECTION DETAILS	24 - 28		DRAWING NO.	GS-01 OF	2	SHEET NO. 5 C) F 29
		PLOTTED:3/6/2017 11:39 AM FILE:J:\91140.04 — Safe Routes to School	Sidewalks\CAD\dwg\GS0	01-02 GEOMETRY SHEET	S.dwg		



LICENSE NO. <u>31168</u>

EXPIRATION DATE: 1/12/2019

CLARK | AZAR & ASSOCIATES


20410 Century Blvd, Suite 230

Germantown, MD. 20874

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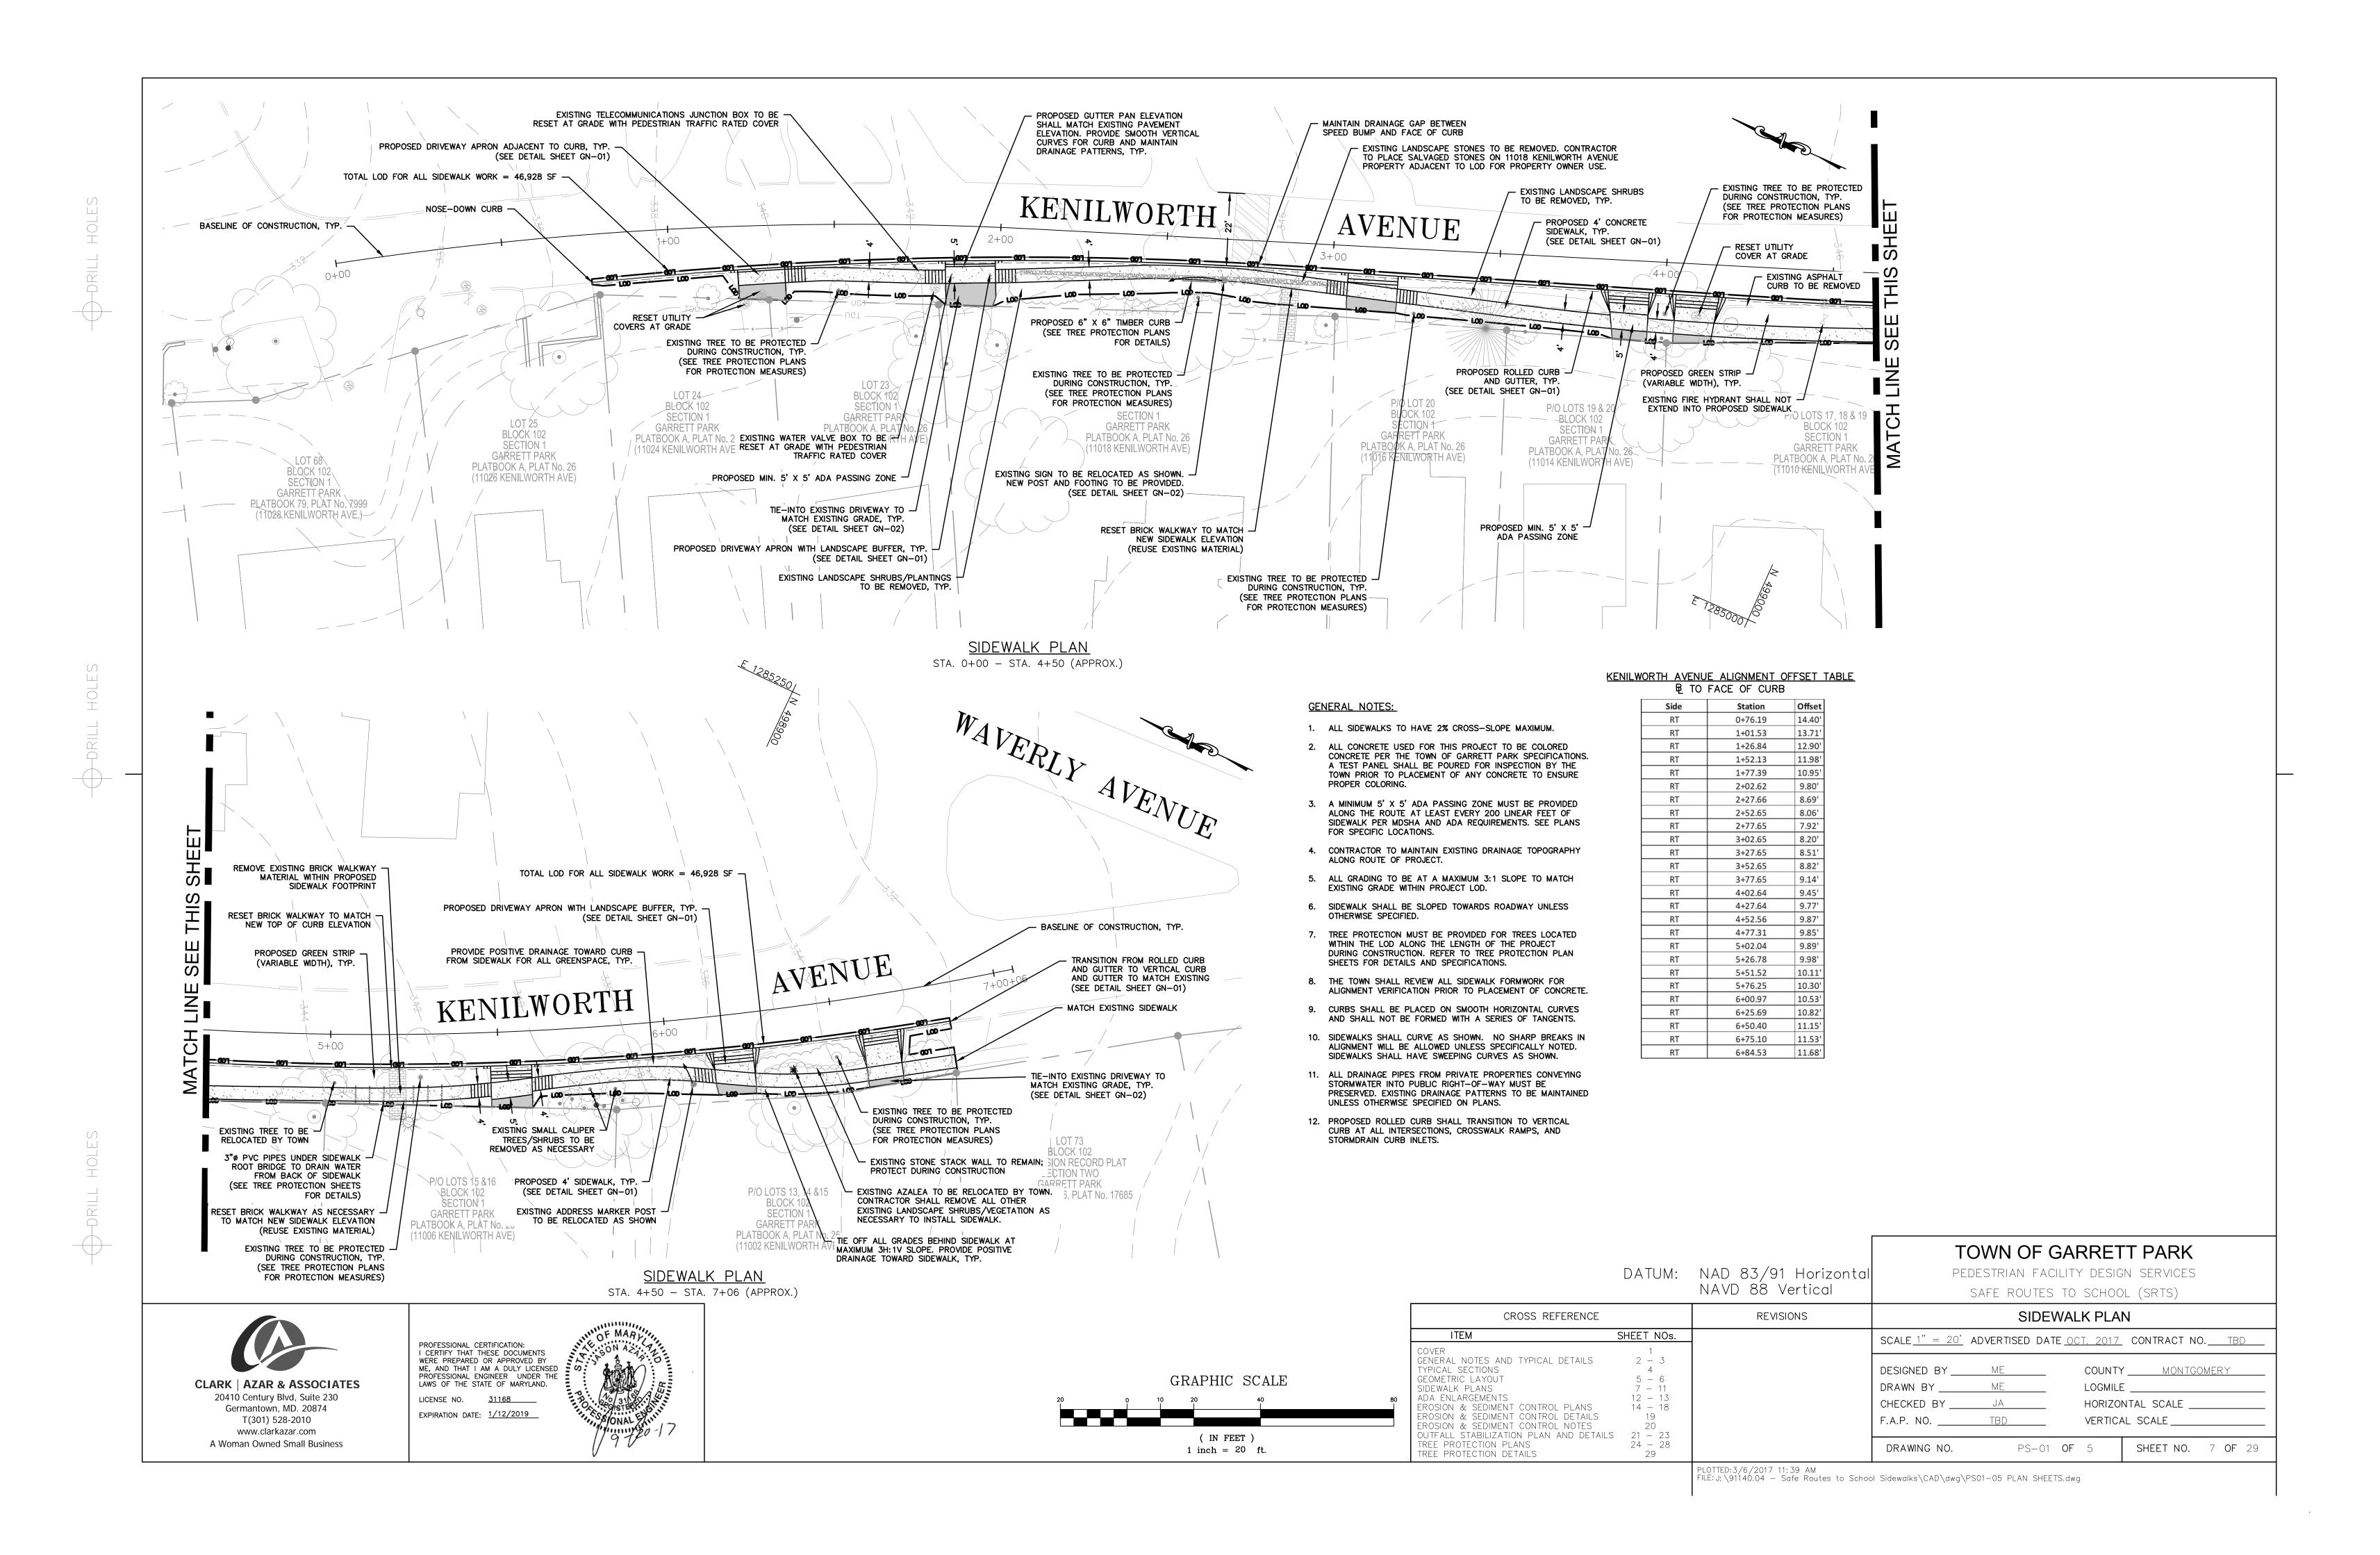
	MONTROSE/CLERMONT BASELINE CONSTRUCTION LINE DATA							
LINE	LENGTH	BEARING	START POINT (NORTHING, EASTING)	END POINT (NORTHING, EASTING)				
L2	176.79	S48° 13' 22"E	(1285642.9769,499257.7143)	(1285774.8175,499139.9291)				
L3	71.42'	S7° 52' 42"E	(1286236.2639,498731.2074)	(1286246.0537,498660.4592)				
L4	76.76	S28° 06' 24"E	(1286286.1951,498536.8620)	(1286322.3602,498469.1499)				
L5	113.66'	S24° 01' 59"W	(1286356.3320,498141.2852)	(1286310.0423,498037.4785)				
L6	63.83'	S12° 46′ 39"W	(1286284.6525,497961.1771)	(1286270.5346,497898.9237)				





TOWN OF GARRETT PARK PEDESTRIAN FACILITY DESIGN SERVICES SAFE ROUTES TO SCHOOL (SRTS)

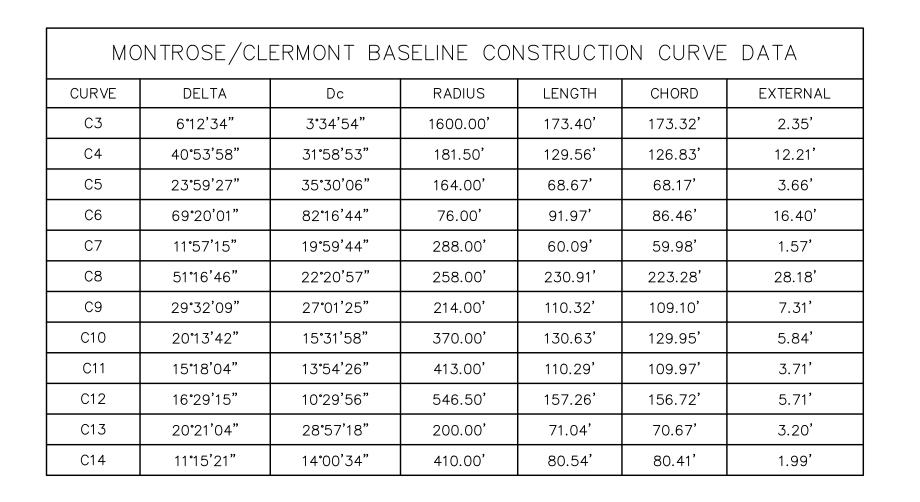
GEOMETRIC LAYOUT REVISIONS CROSS REFERENCE ITEM SHEET NOs. SCALE 1" = 60' ADVERTISED DATE OCT. 2017 CONTRACT NO. TBD COVER
GENERAL NOTES AND TYPICAL DETAILS
TYPICAL SECTIONS
GEOMETRIC LAYOUT
SIDEWALK PLANS
ADA ENLARGEMENTS
EPOSION & SEDIMENT CONTROL DI ANS DESIGNED BY ___ COUNTY MONTGOMERY LOGMILE _ HORIZONTAL SCALE ROSION & SEDIMENT CONTROL PLANS EROSION & SEDIMENT CONTROL PLANS
EROSION & SEDIMENT CONTROL DETAILS
EROSION & SEDIMENT CONTROL NOTES
OUTFALL STABILIZATION PLAN AND DETAILS
TREE PROTECTION PLANS
TREE PROTECTION DETAILS 19 VERTICAL SCALE_ 21 – 23 24 - 28 DRAWING NO. SHEET NO. 6 OF 29 GS-02 **OF** 2 PLOTTED: 3/6/2017 11: 39 AM FILE: J: 91140.04 - Safe Routes to School Sidewalks CAD dwg GS01-02 GEOMETRY SHEETS.dwg


GRAPHIC SCALE (IN FEET) 1 inch = 60 ft.




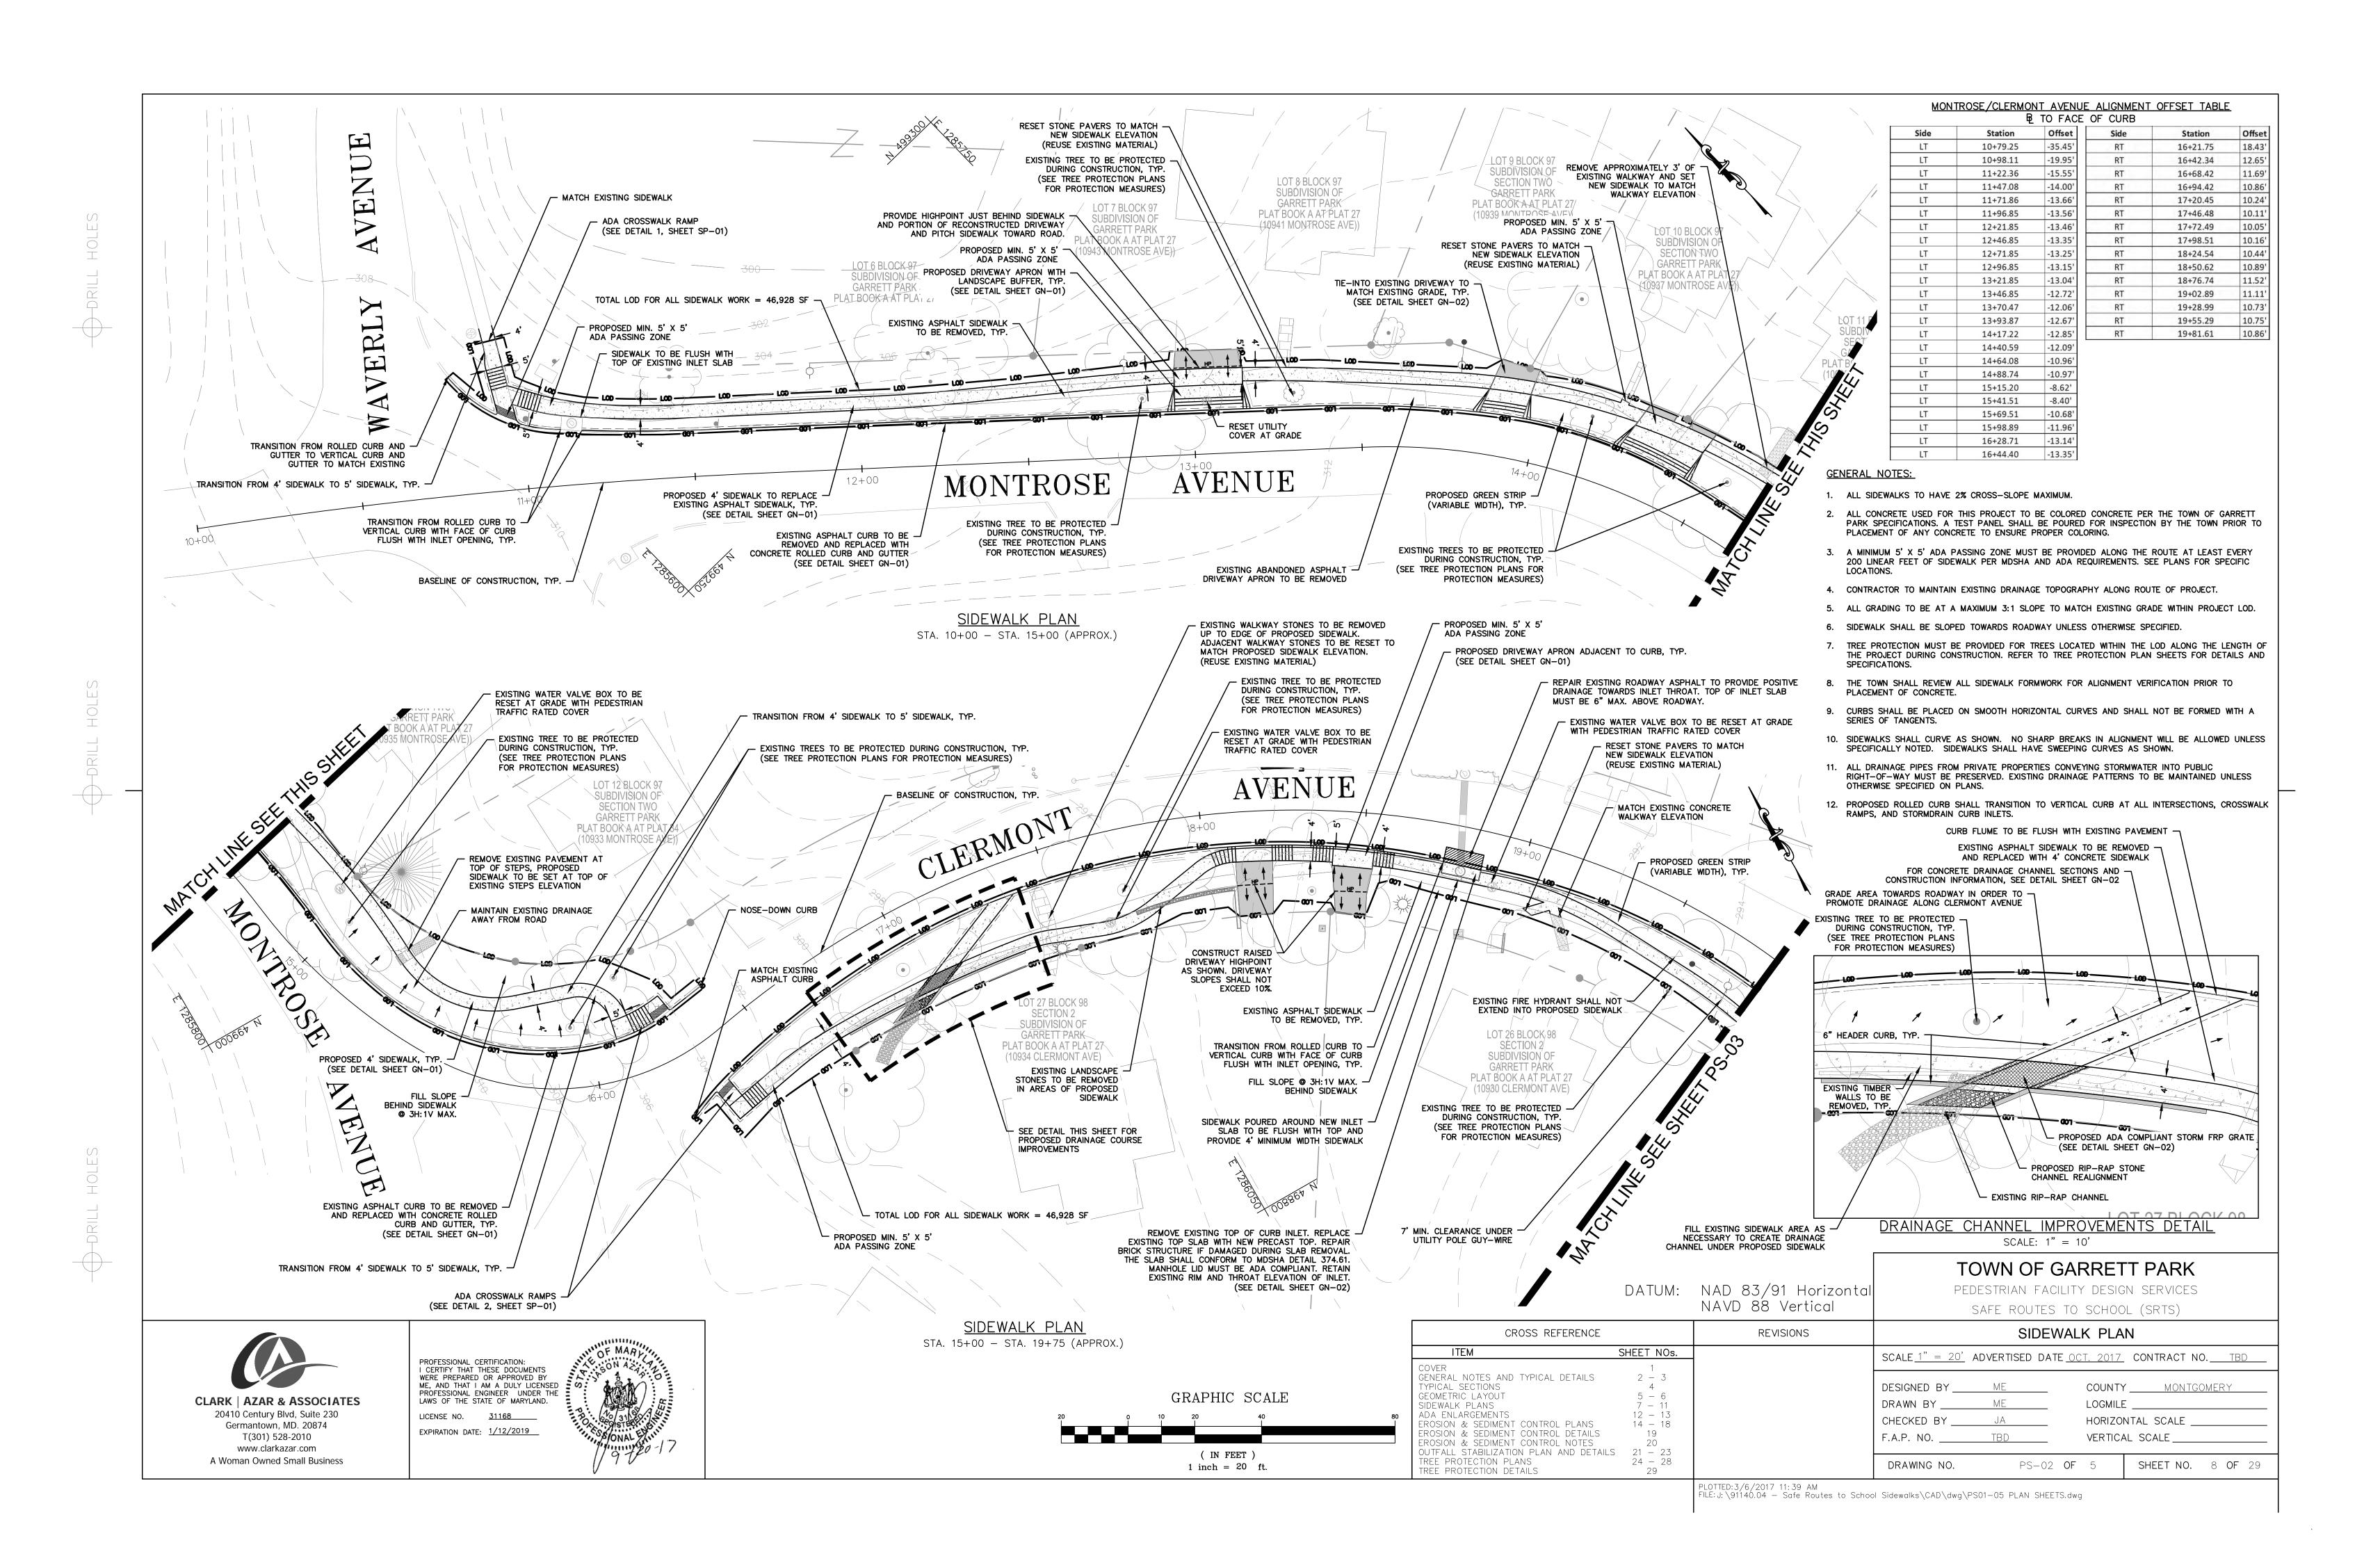

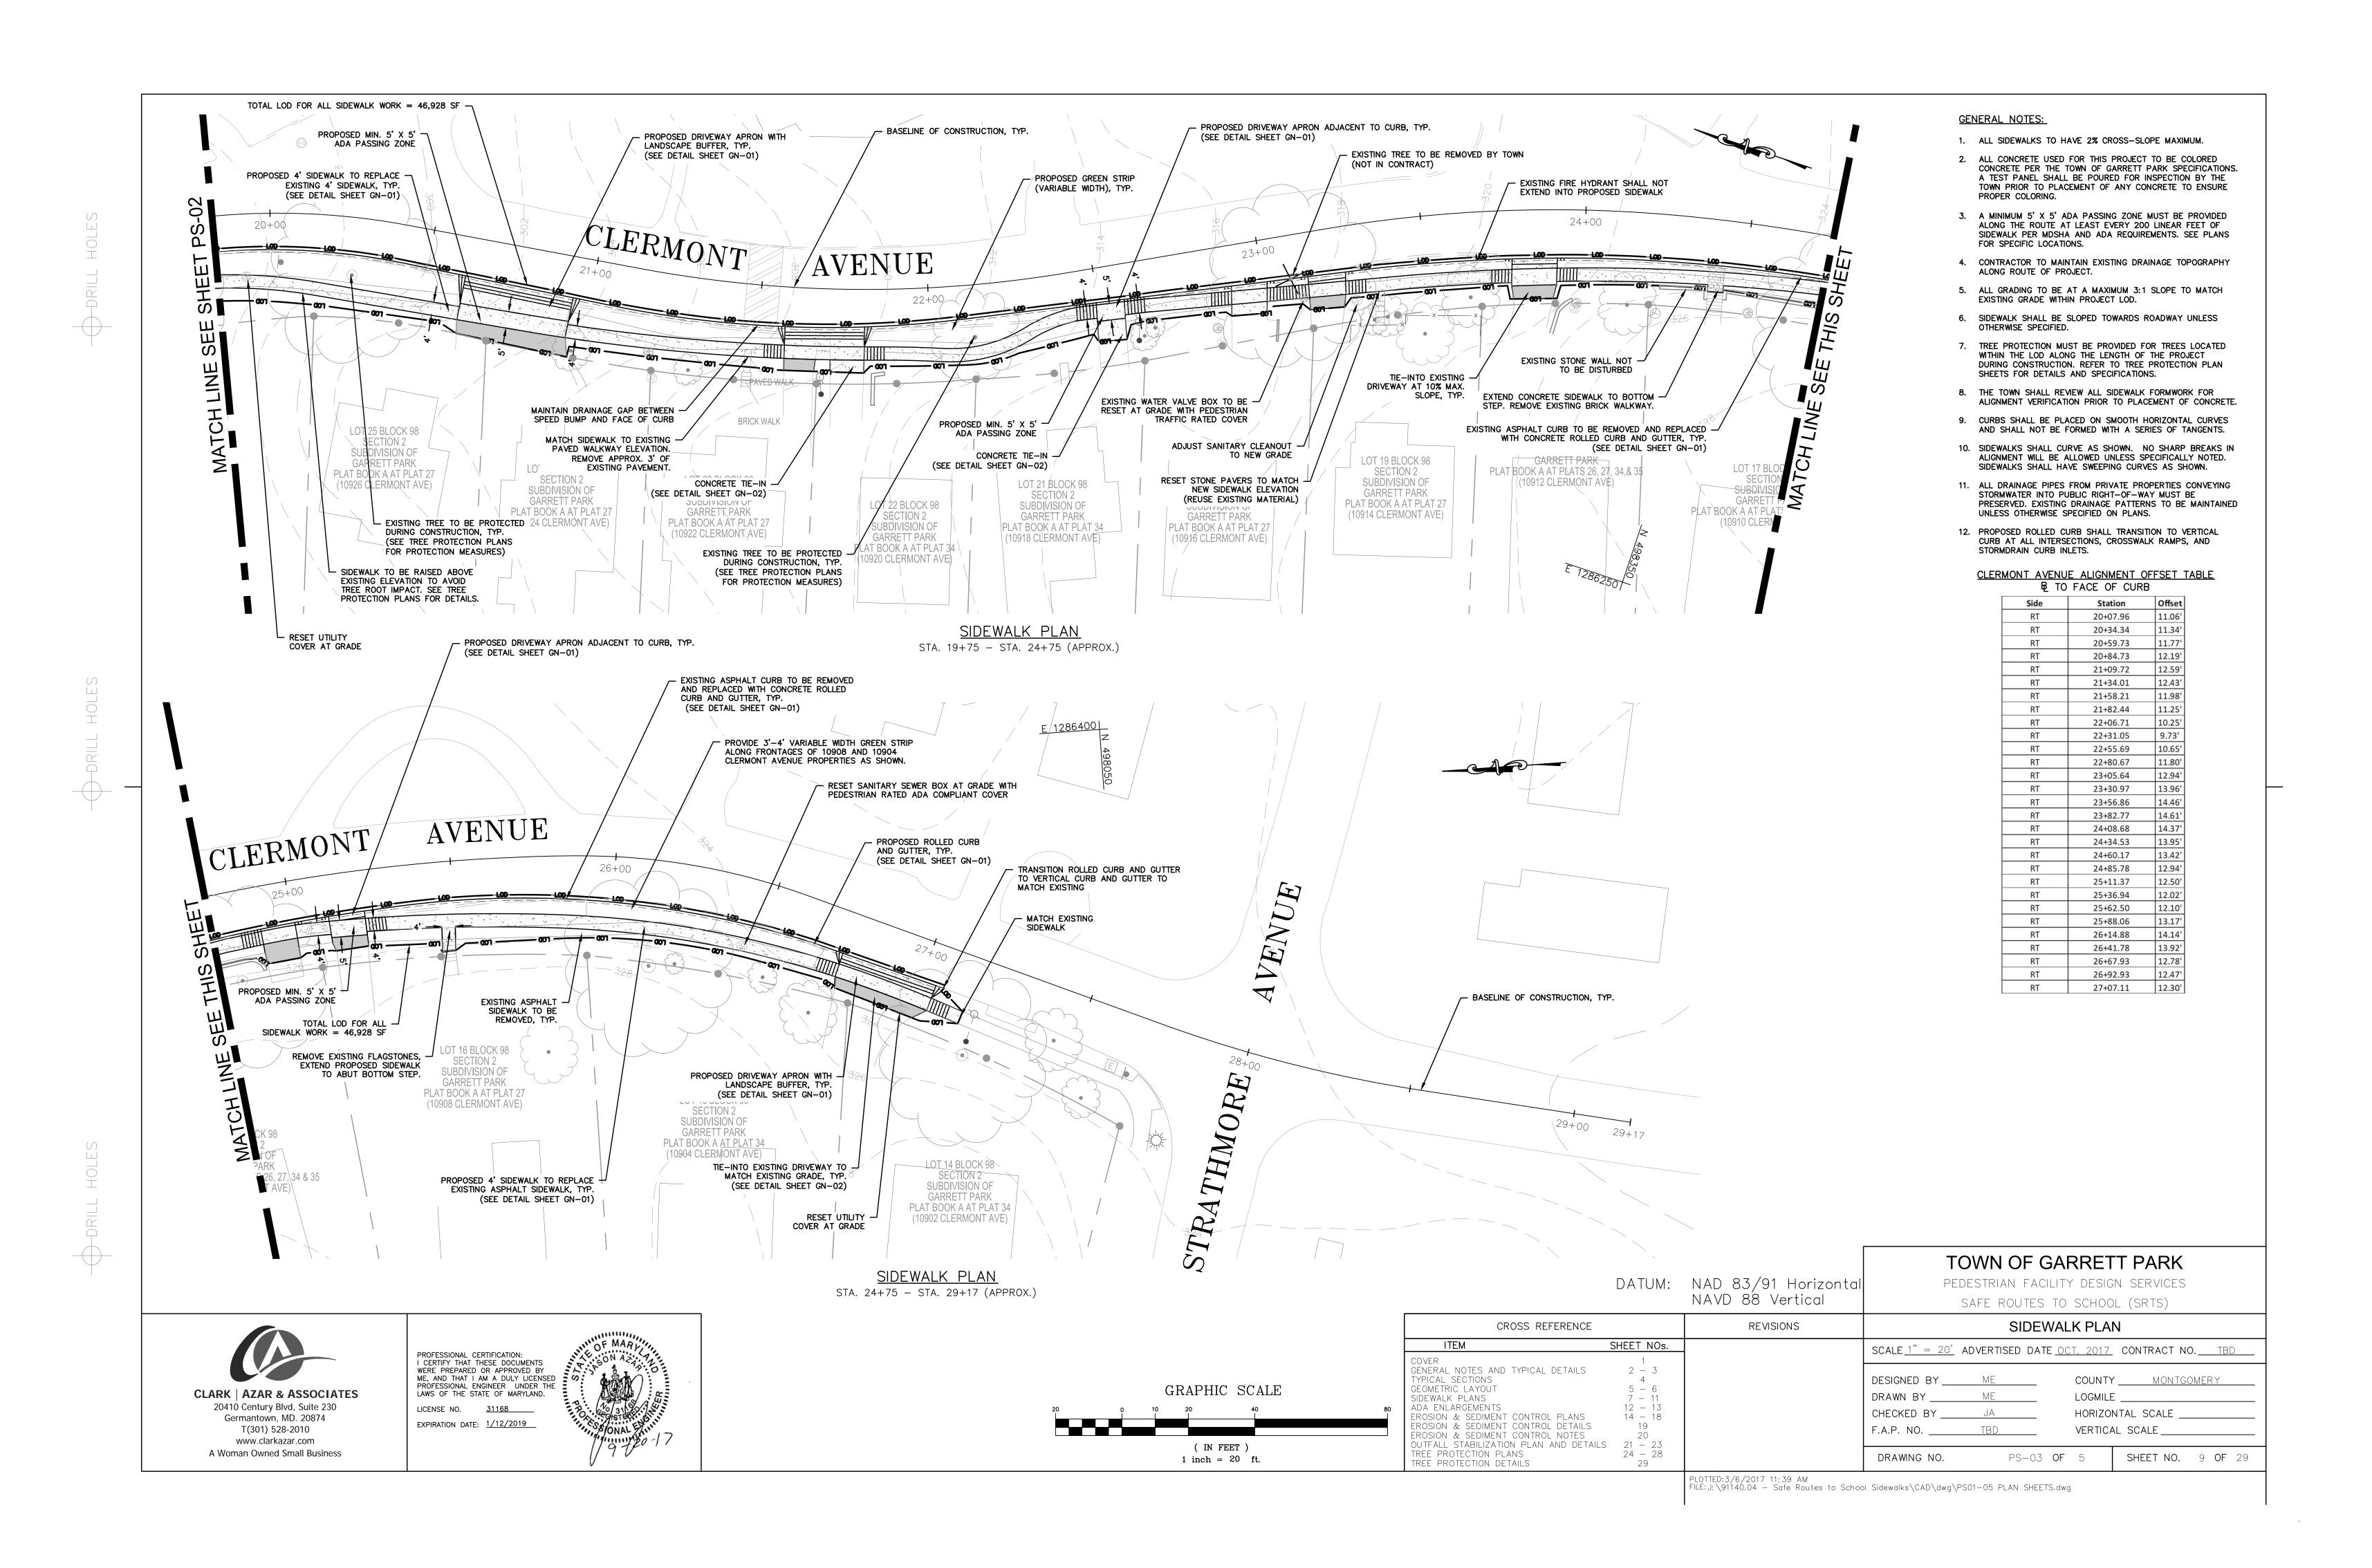

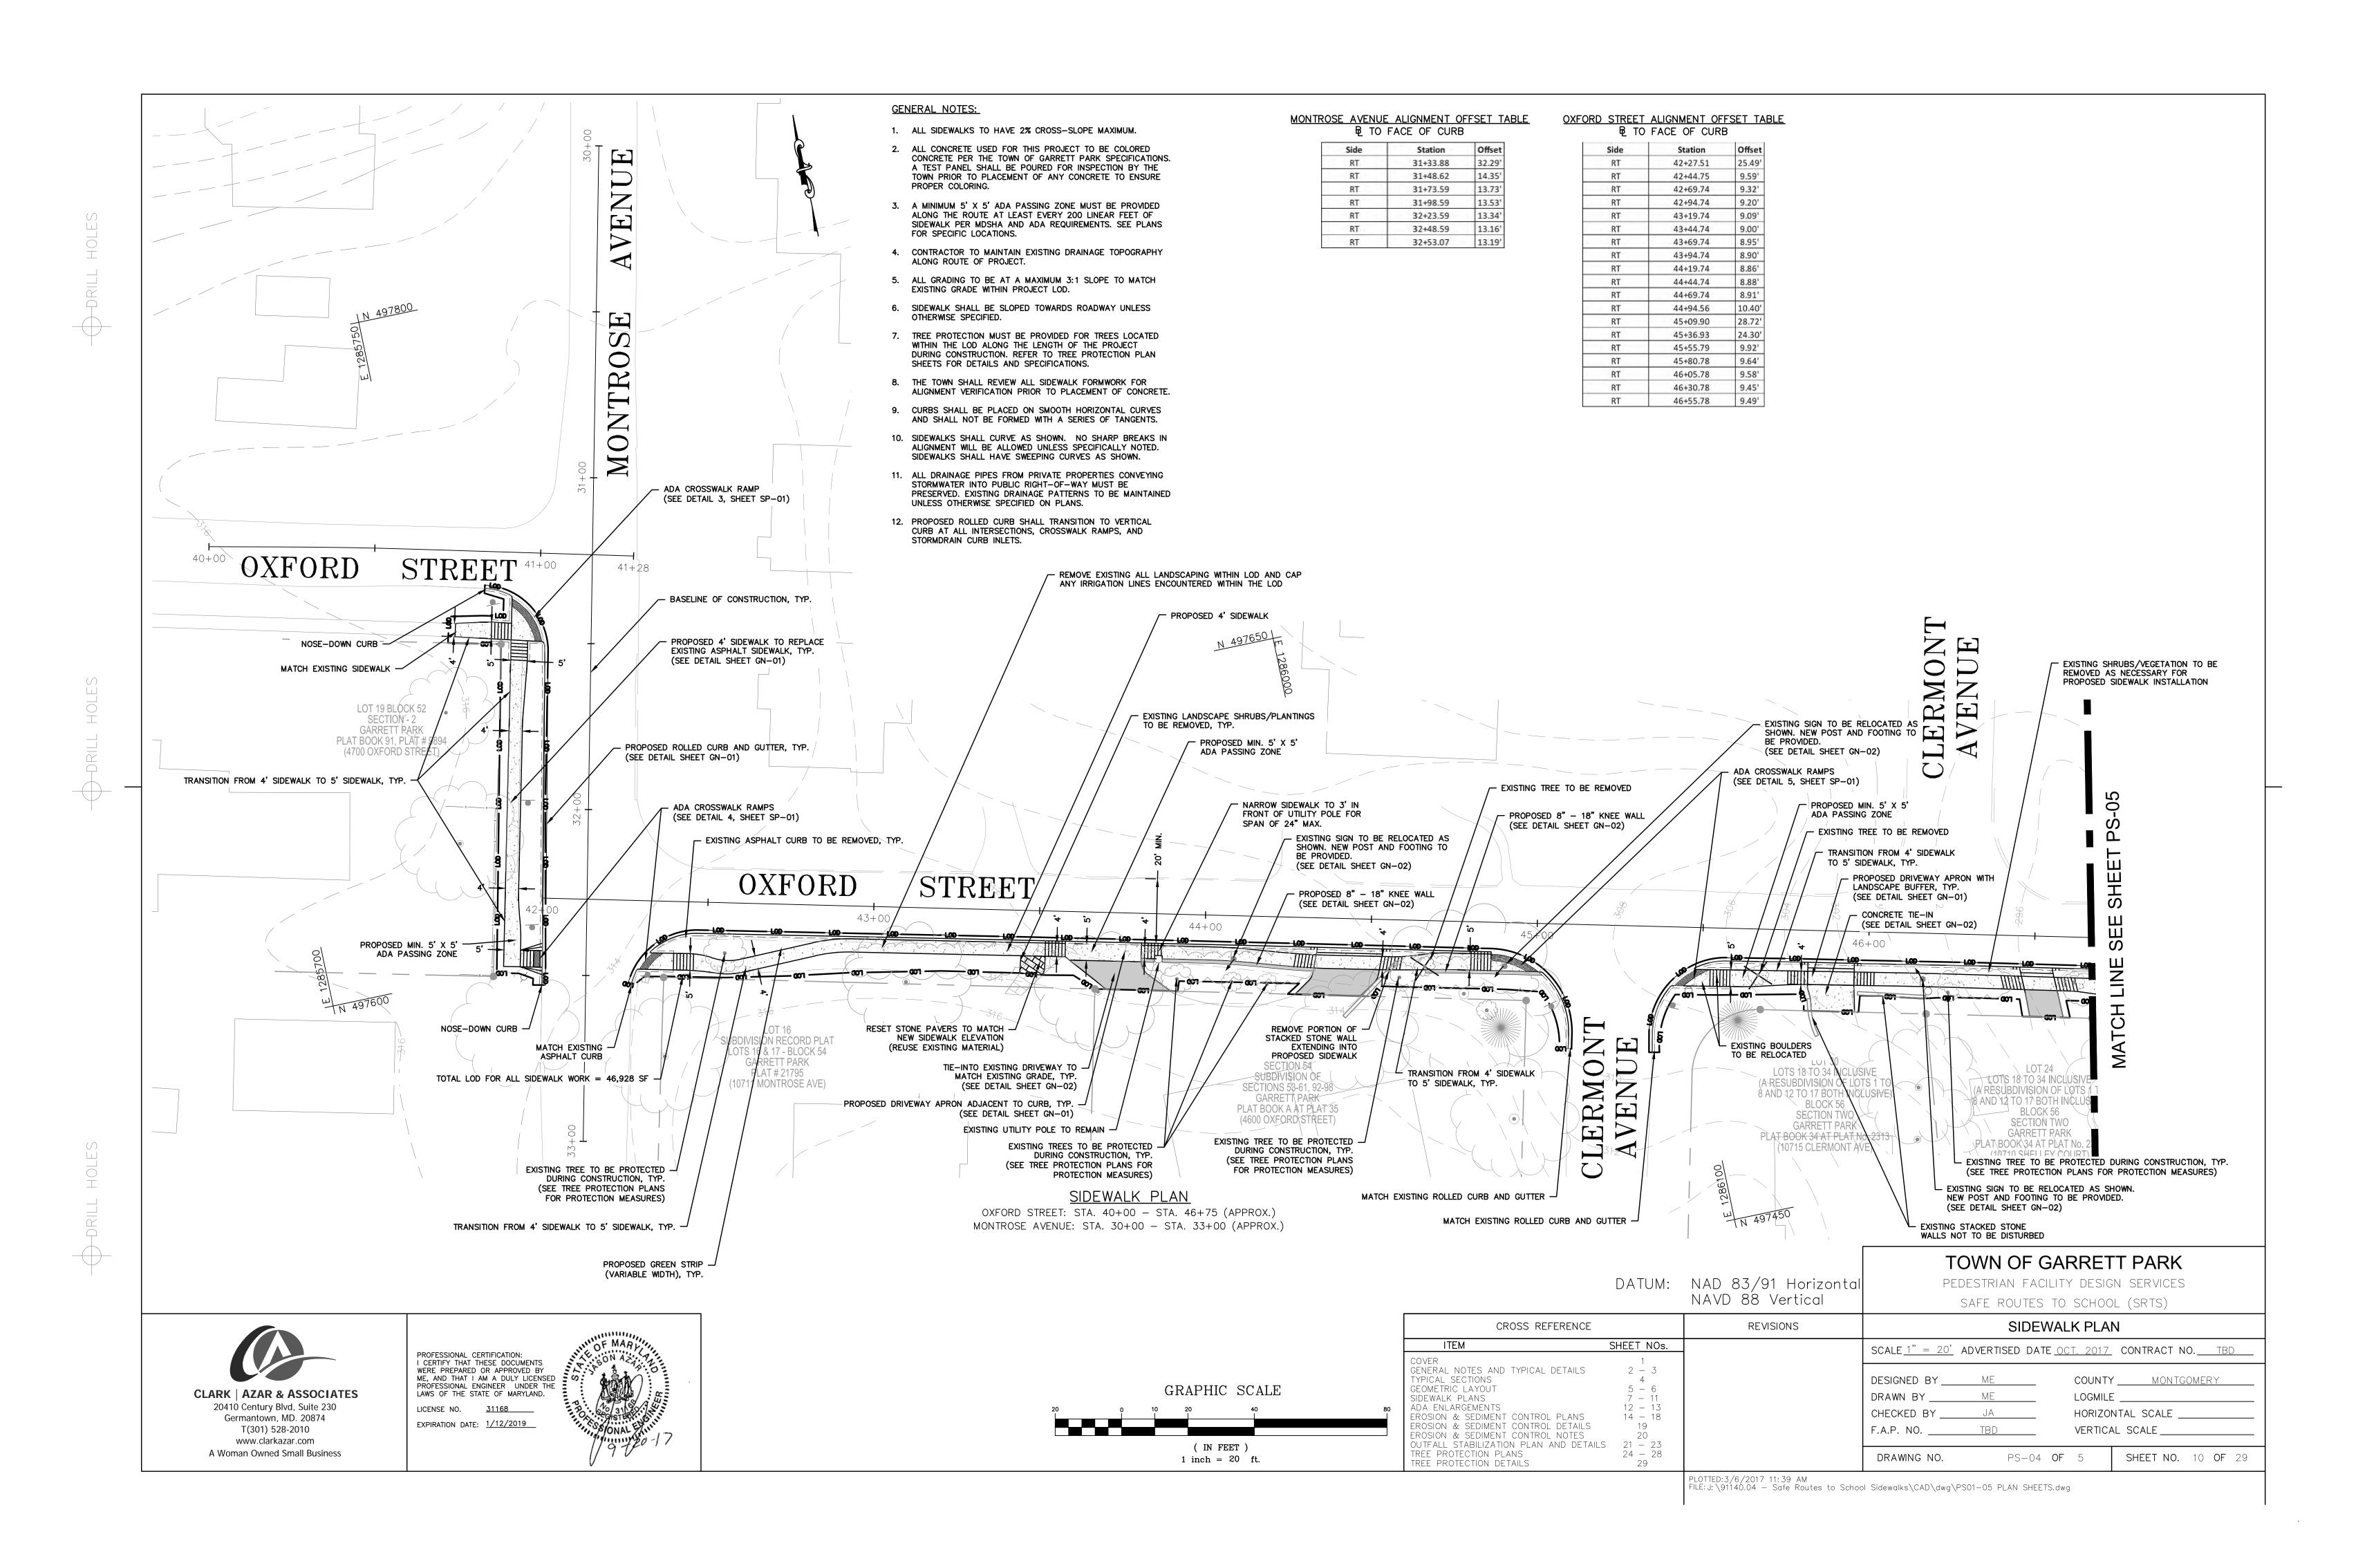

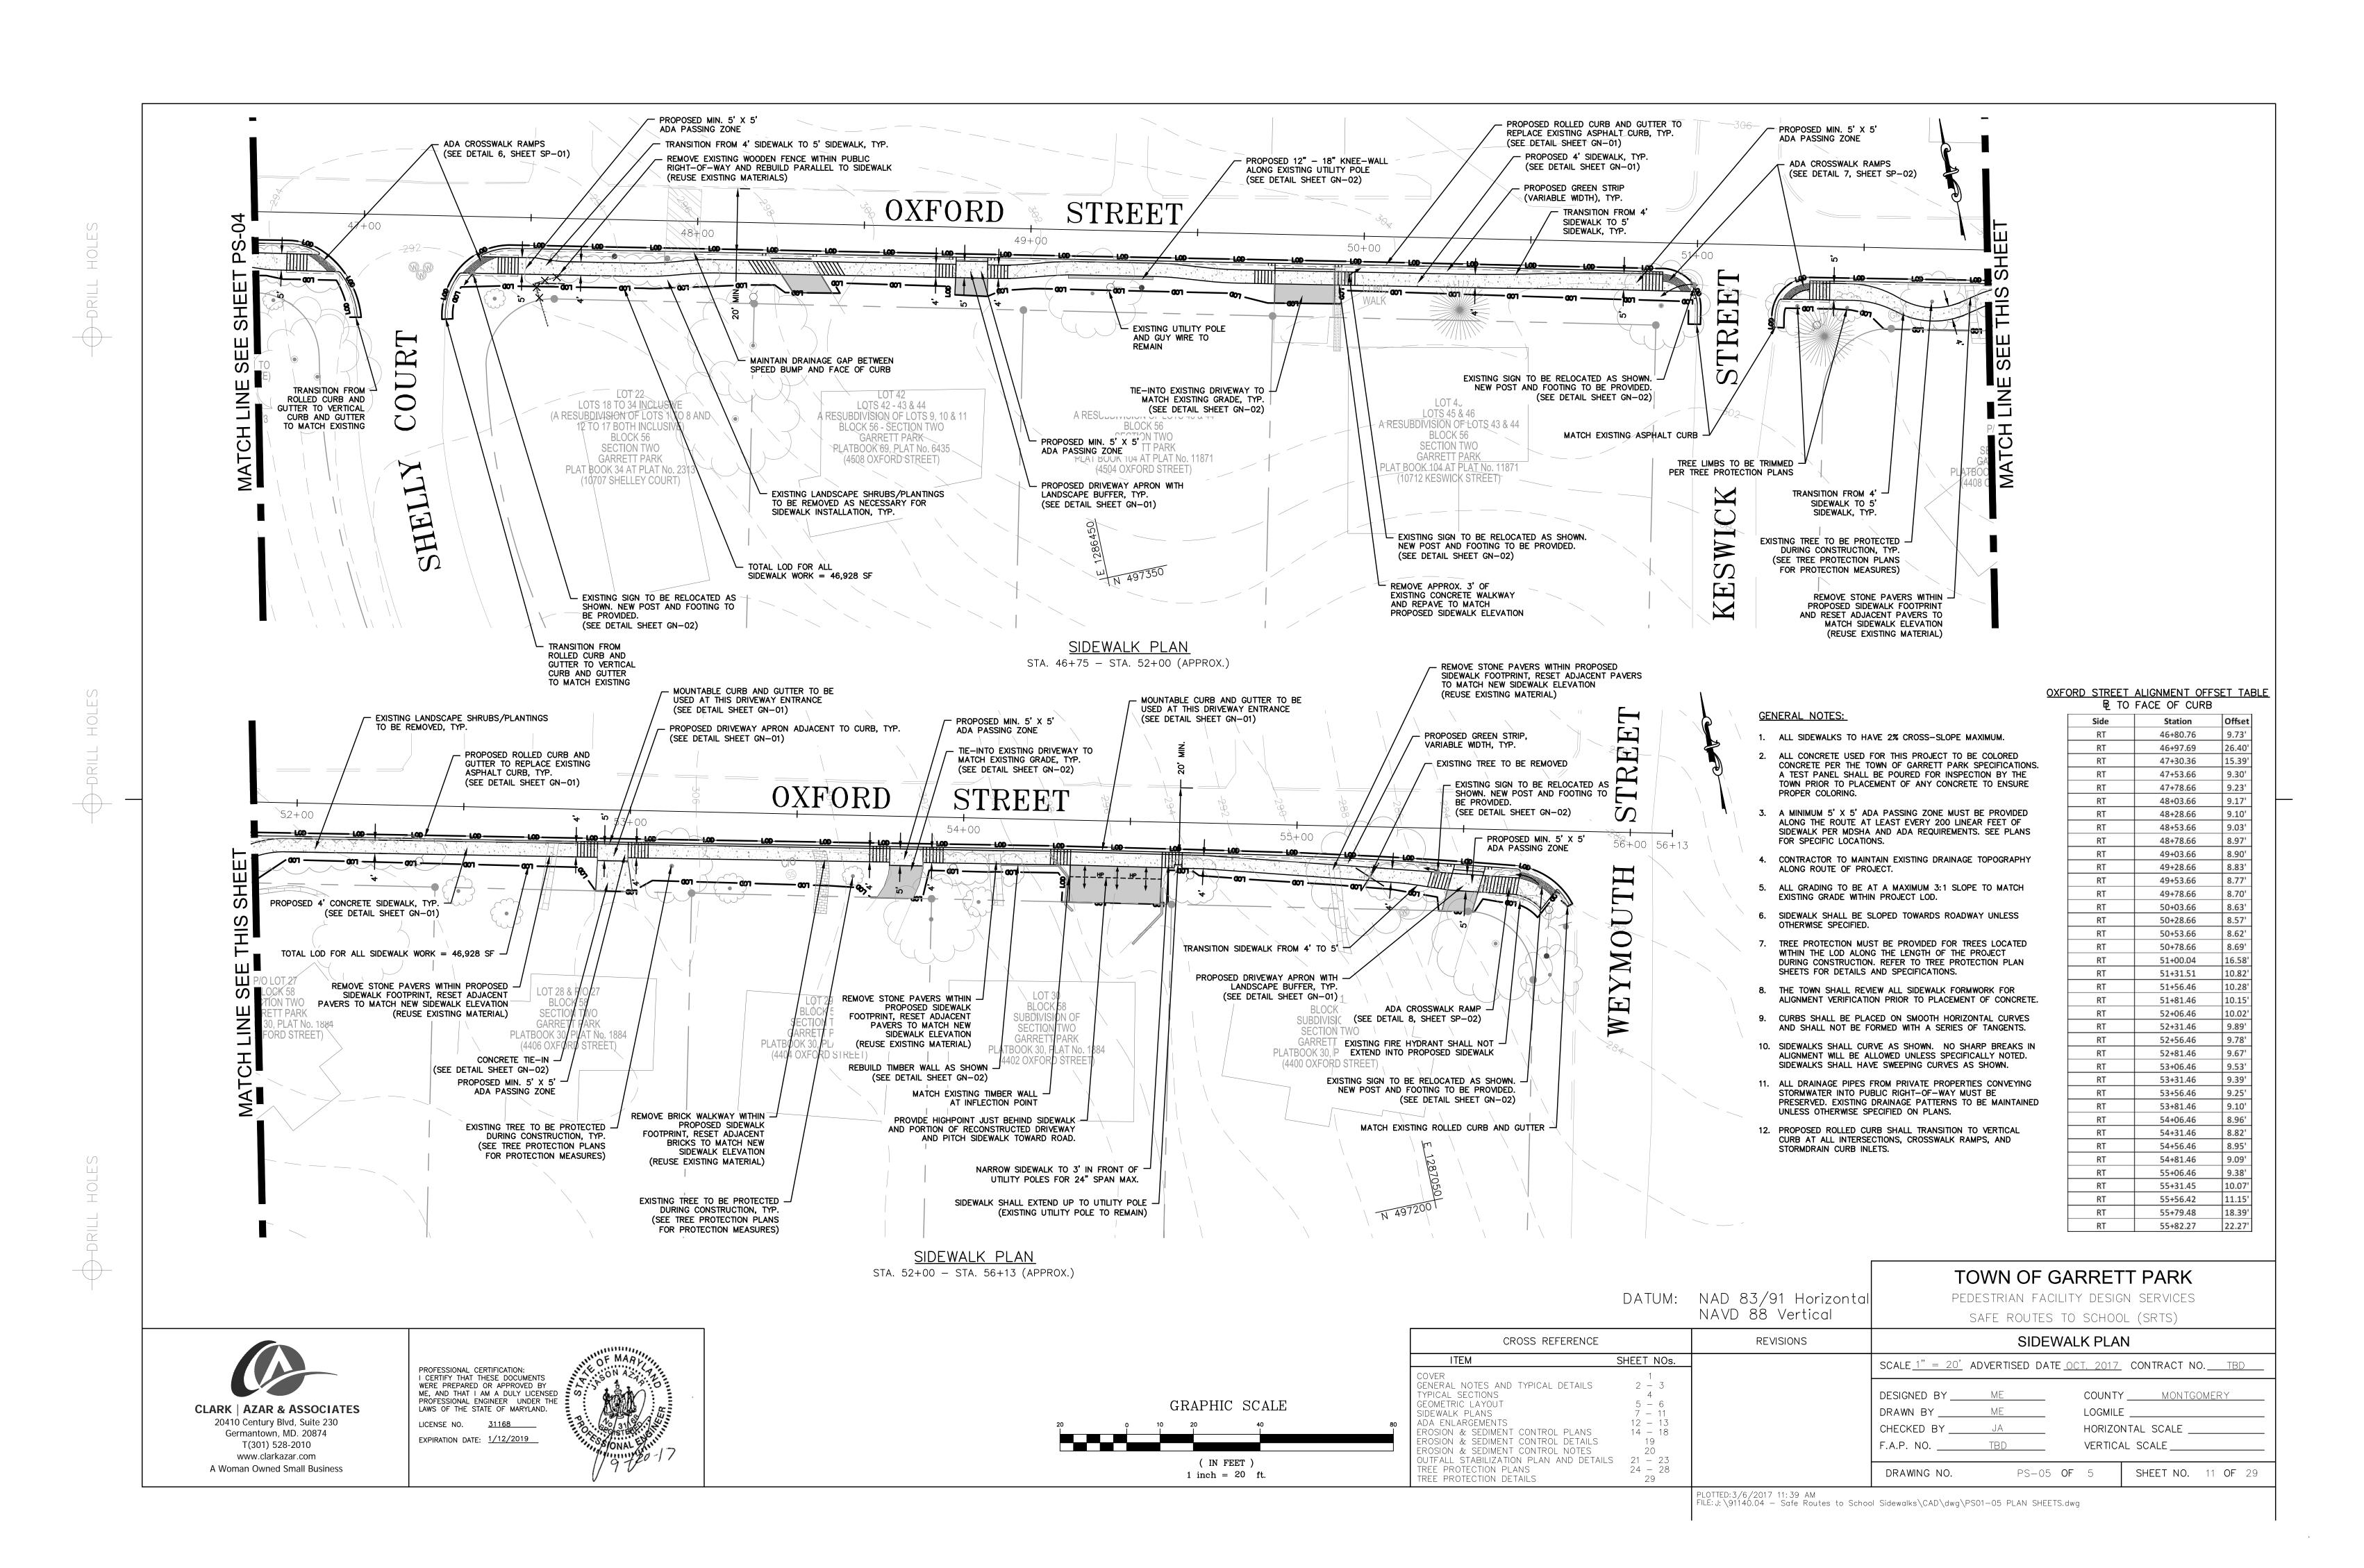


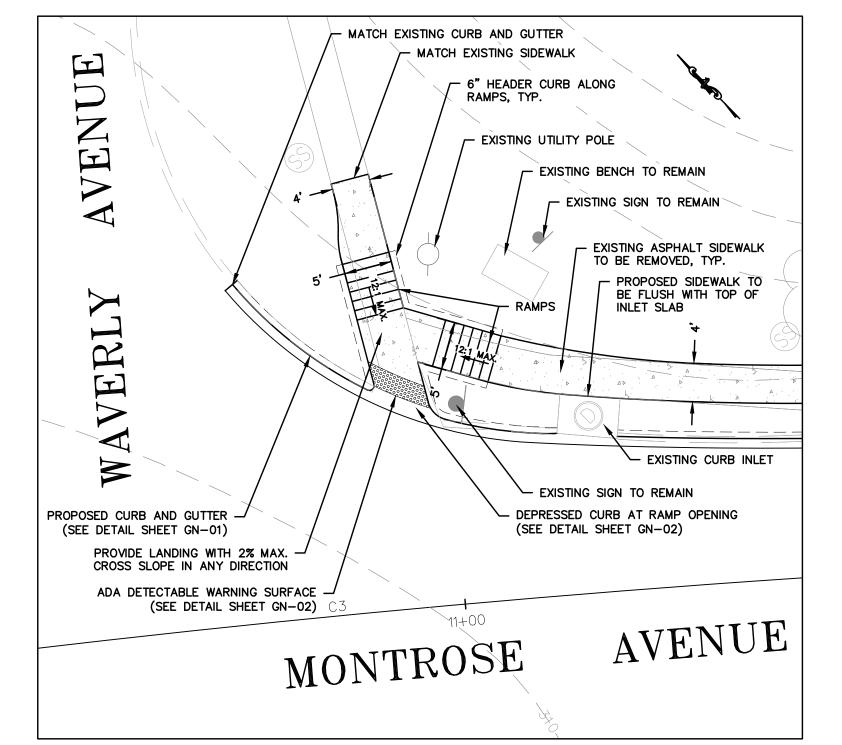

ADA CROSSWALK RAMP ENLARGEMENT 1

MONTROSE AVENUE STA. 11+00 LT (APPROX.)

SCALE: 1" = 10'

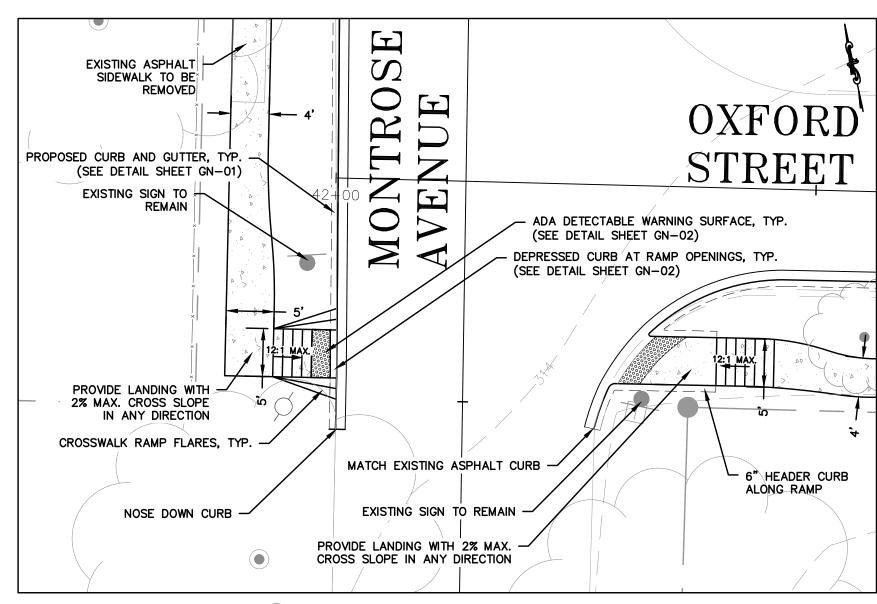



ADA CROSSWALK RAMP ENLARGEMENT 4 OXFORD STREET STA. 42+00 RT & STA. 42+30 RT (APPROX.)

GENERAL NOTES:

- 1. NO TRAVERSABLE SLOPE ON THE RAMP OR SIDEWALK SHALL EXCEED 12:1 IN THE DIRECTION OF PEDESTRIAN TRAVEL, OR 48:1 PERPENDICULAR TO THE DIRECTION OF PEDESTRIAN TRAVEL. THE CROSS-SLOPE OF THE LANDING AREA CANNOT EXCEED GRADE OF ROADWAY.
- 2. EXPANSION JOINT MATERIAL SHALL BE INSTALLED IN ACCORDANCE WITH MDSHA STD. MD-655.01.
- 3. SURFACE TEXTURE OF RAMPS SHALL BE COURSE BROOMING OR NON-SKID TYPE SURFACE.



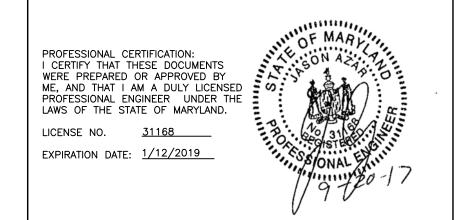


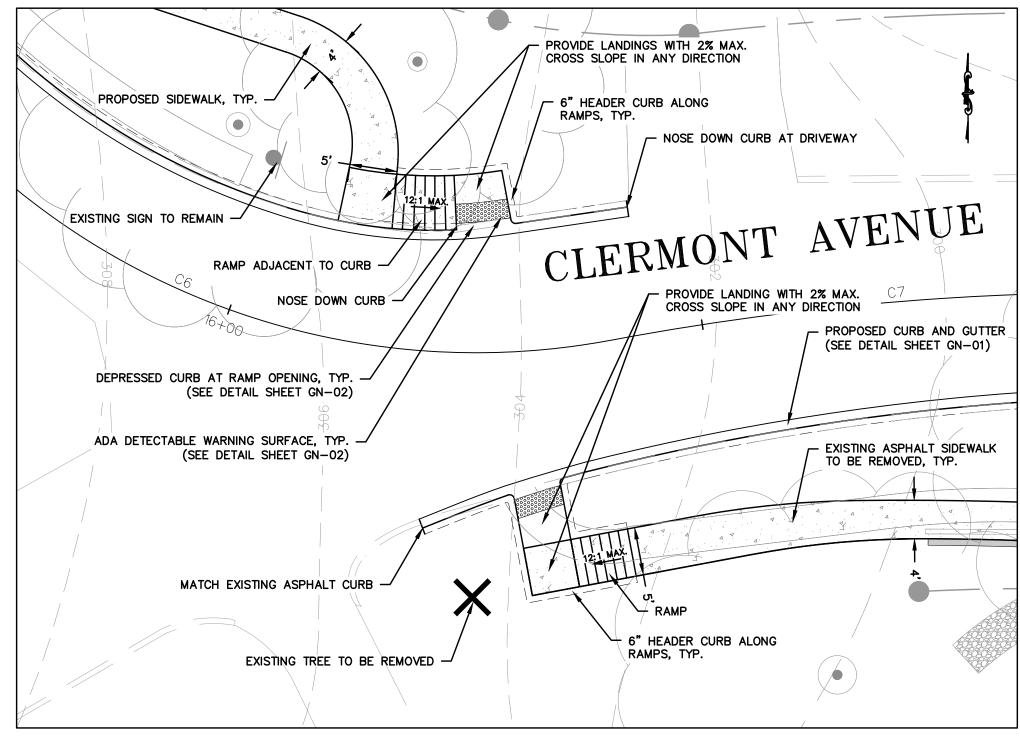


ADA CROSSWALK RAMP ENLARGEMENT 2


CLERMONT AVENUE STA. 16+30 LT & RT (APPROX.)

SCALE: 1" = 10'

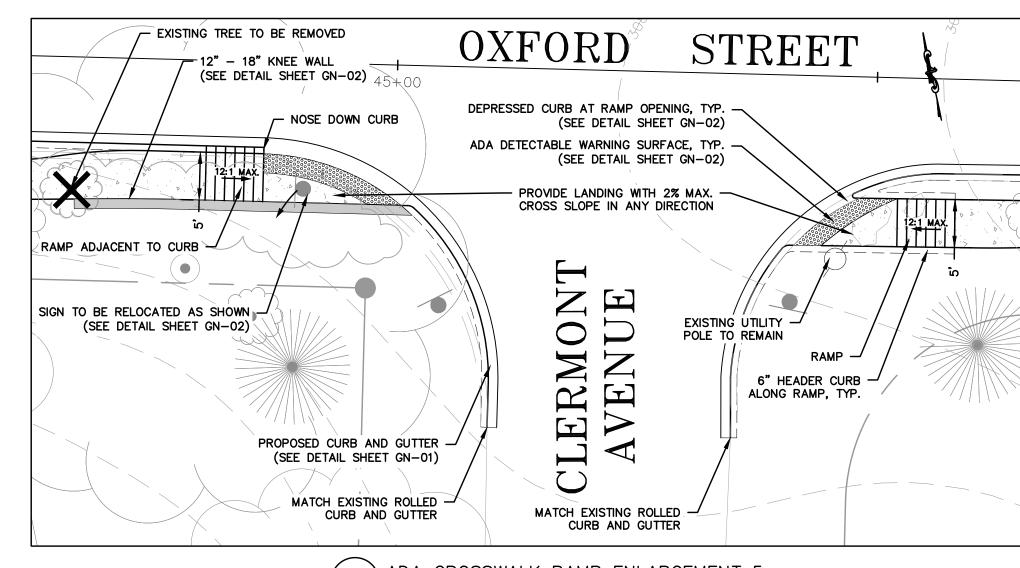

ADA CROSSWALK RAMP ENLARGEMENT 5 FORD STREET STA. 45+00 RT & STA. 45+50 RT (APPROX.)

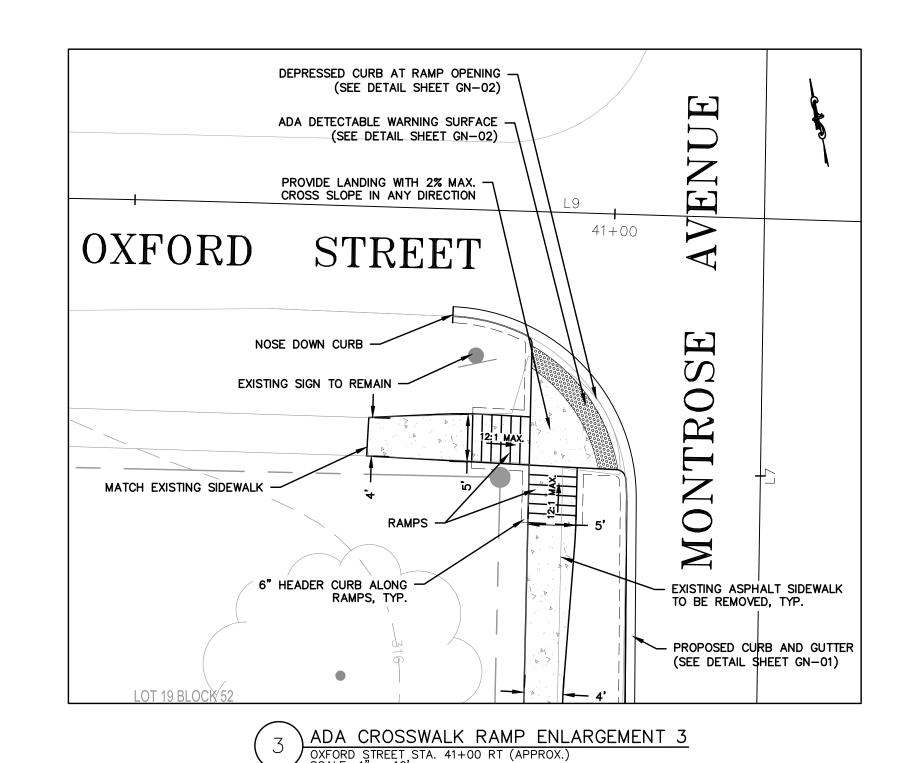

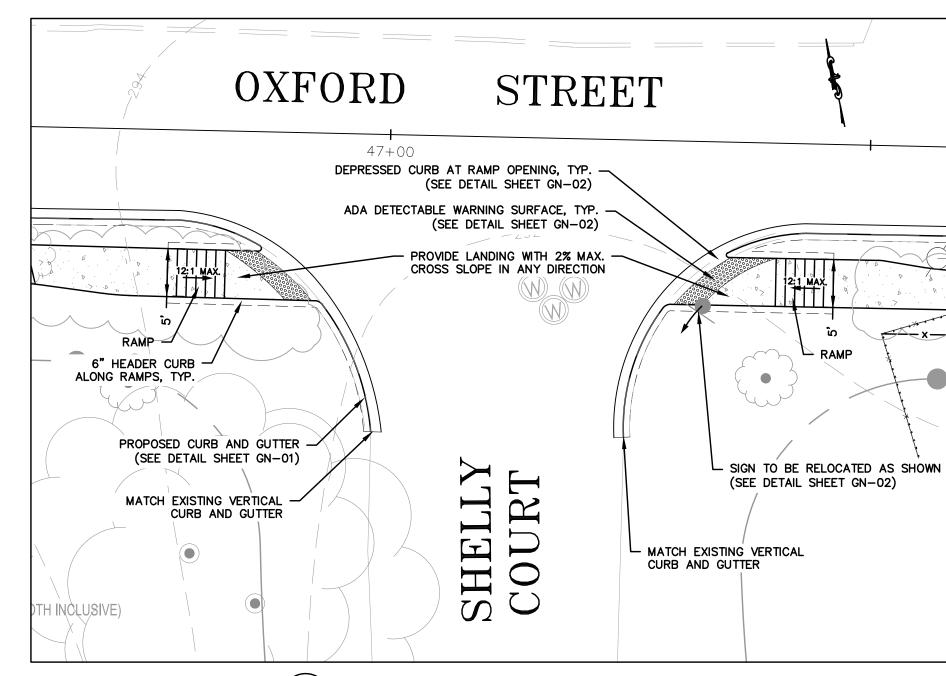


ADA CROSSWALK RAMP ENLARGEMENT 6 OXFORD STREET STA. 46+80 RT & STA. 47+30 RT (APPROX.) SCALE: 1" = 10'


TOWN OF GARRETT PARK

PEDESTRIAN FACILITY DESIGN SERVICES

DATUM: NAD 83/91 Horizontal NAVD 88 Vertical REVISIONS CROSS REFERENCE

SAFE ROUTES TO SCHOOL (SRTS) ADA ENLARGEMENTS ITEM SHEET NOs. SCALE 1" = 10' ADVERTISED DATE OCT. 2017 CONTRACT NO. TBD COVER GENERAL NOTES AND TYPICAL DETAILS TYPICAL SECTIONS DESIGNED BY ____ COUNTY _____MONTGOMERY GRAPHIC SCALE GEOMETRIC LAYOUT DRAWN BY LOGMILE _ SIDEWALK PLANS 7 – 11 ADA ENLARGEMENTS CHECKED BY _____ HORIZONTAL SCALE ROSION & SEDIMENT CONTROL PLANS ROSION & SEDIMENT CONTROL DETAILS 19 F.A.P. NO. _ VERTICAL SCALE EROSION & SEDIMENT CONTROL NOTES OUTFALL STABILIZATION PLAN AND DETAILS 21 - 23 (IN FEET) TREE PROTECTION PLANS
TREE PROTECTION DETAILS 24 - 28 **SHEET NO.** 12 **OF** 29 DRAWING NO. SP-01 **OF** 2 1 inch = 10 ft.PLOTTED:3/6/2017 11:39 AM FILE: J:\91140.04 - Safe Routes to School Sidewalks\CAD\dwg\SP01-02 ADA ENLARGEMENTS.dwg

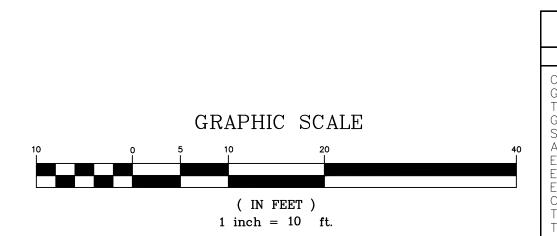

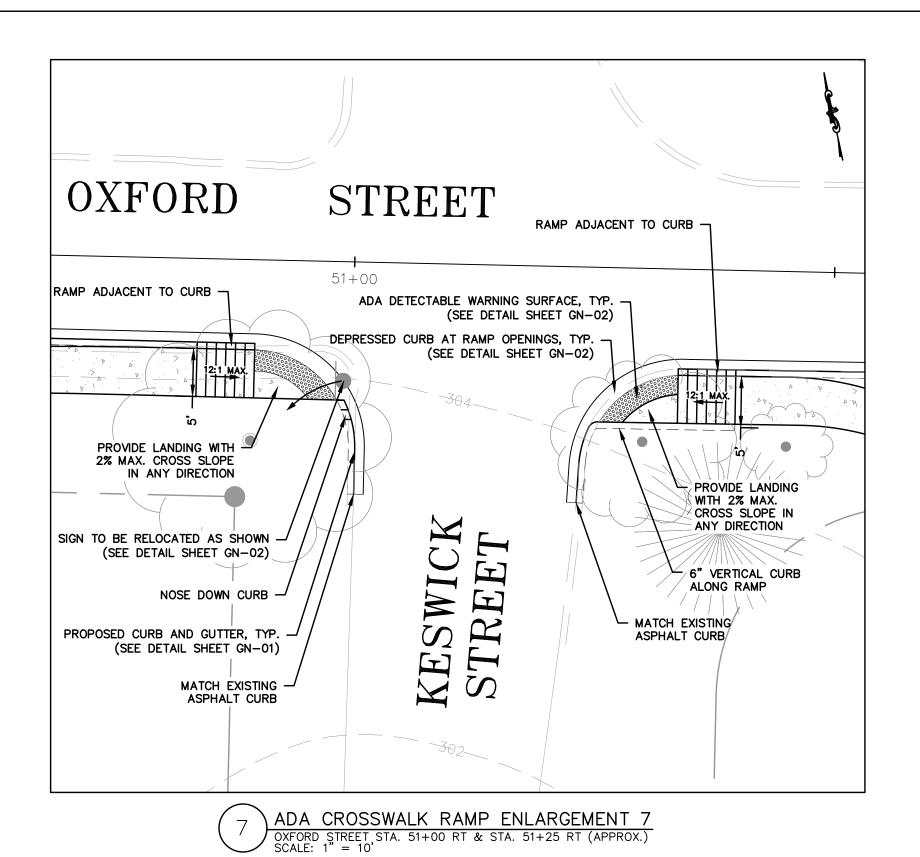

OXFORD STREET

SIGN TO BE RELOCATED AS SHOWN (SEE DETAIL SHEET CN-02)

ADA DETECTABLE WARNING SURFACE, TYP: (SEE DETAIL SHEET CN-02)

DEPRESSED CURB AT RAMP OPENINGS, TYP: (SEE DETAIL SHEET CN-02)

DEPRESSED CURB AT RAMP OPENINGS, TYP: (SEE DETAIL SHEET CN-02)

EXISTING FIRE HYDRANT NOT TO OBSTRUCT PROPOSED CROSSWALK, CVIRTICAL CURB TO BE CONSTRUCTED OB CONSTRUCT PROPOSED CROSSWALK, CVIRTICAL CURB TO BE CONSTRUCTED.

OBSTRUCT PROPOSED CROSSWALK, CVIRTICAL CURB TO BE CONSTRUCTED.

OBSTRUCT PROPOSED CROSSWALK, CVIRTICAL CURB TO THE CONSTRUCT PROPOSED CROSSWALK, CVIRTICAL CROSS SLOPE IN ANY DIRECTION.


MATCH EXISTING ROLLED CURB AND GUITER


ADA CROSSCHALLY DAMPS THE ADDITIONAL CROSS SLOPE IN ANY DIRECTION.

8 ADA CROSSWALK RAMP ENLARGEMENT 8
OXFORD STREET, STA. 55+75 RT (APPROX.)
SCALE: 1" = 10'

GENERAL NOTES:

- NO TRAVERSABLE SLOPE ON THE RAMP OR SIDEWALK SHALL EXCEED 12:1 IN THE DIRECTION OF PEDESTRIAN TRAVEL, OR 48:1 PERPENDICULAR TO THE DIRECTION OF PEDESTRIAN TRAVEL. THE CROSS—SLOPE OF THE LANDING AREA CANNOT EXCEED GRADE OF ROADWAY.
- 2. EXPANSION JOINT MATERIAL SHALL BE INSTALLED IN ACCORDANCE WITH MDSHA STD. MD-655.01.
- 3. SURFACE TEXTURE OF RAMPS SHALL BE COURSE BROOMING OR NON-SKID TYPE SURFACE.

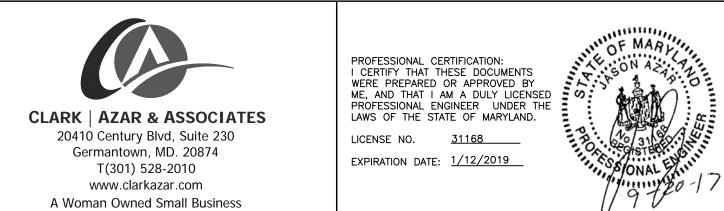

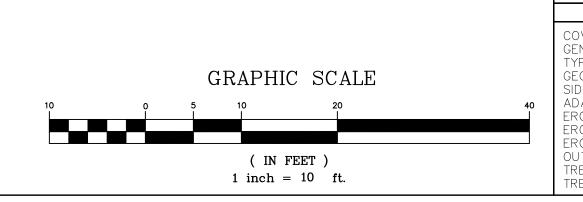



DATUM: NAD 83/91 Horizontal NAVD 88 Vertical


TOWN OF GARRETT PARK PEDESTRIAN FACILITY DESIGN SERVICES SAFE ROUTES TO SCHOOL (SRTS)


CROSS REFERENCE		REVISIONS	ADA ENLARGEMENTS			
ITEM	SHEET NOs.		SCALE 1" = 10' ADVERTISE	D DATE OCT. 2017	CONTRACT NO. TBD	
VER NERAL NOTES AND TYPICAL DETAILS PICAL SECTIONS OMETRIC LAYOUT SEWALK PLANS A ENLARGEMENTS OSION & SEDIMENT CONTROL PLANS OSION & SEDIMENT CONTROL DETAILS OSION & SEDIMENT CONTROL NOTES TFALL STABILIZATION PLAN AND DETAILS	1 2 - 3 4 5 - 6 7 - 11 12 - 13 14 - 18 19 20 5 21 - 23		DESIGNED BYMEMEME	COUNTY LOGMILE HORIZON	MONTGOMERY TAL SCALE	
EE PROTECTION PLANS EE PROTECTION DETAILS	24 - 28 29		DRAWING NO. S	SP-02 OF 2	SHEET NO. 13 OF 29	
		PLOTTED:3/6/2017 11:39 AM		-		


FILE: J: \91140.04 - Safe Routes to School Sidewalks\CAD\dwg\SP01-02 ADA ENLARGEMENTS.dwg

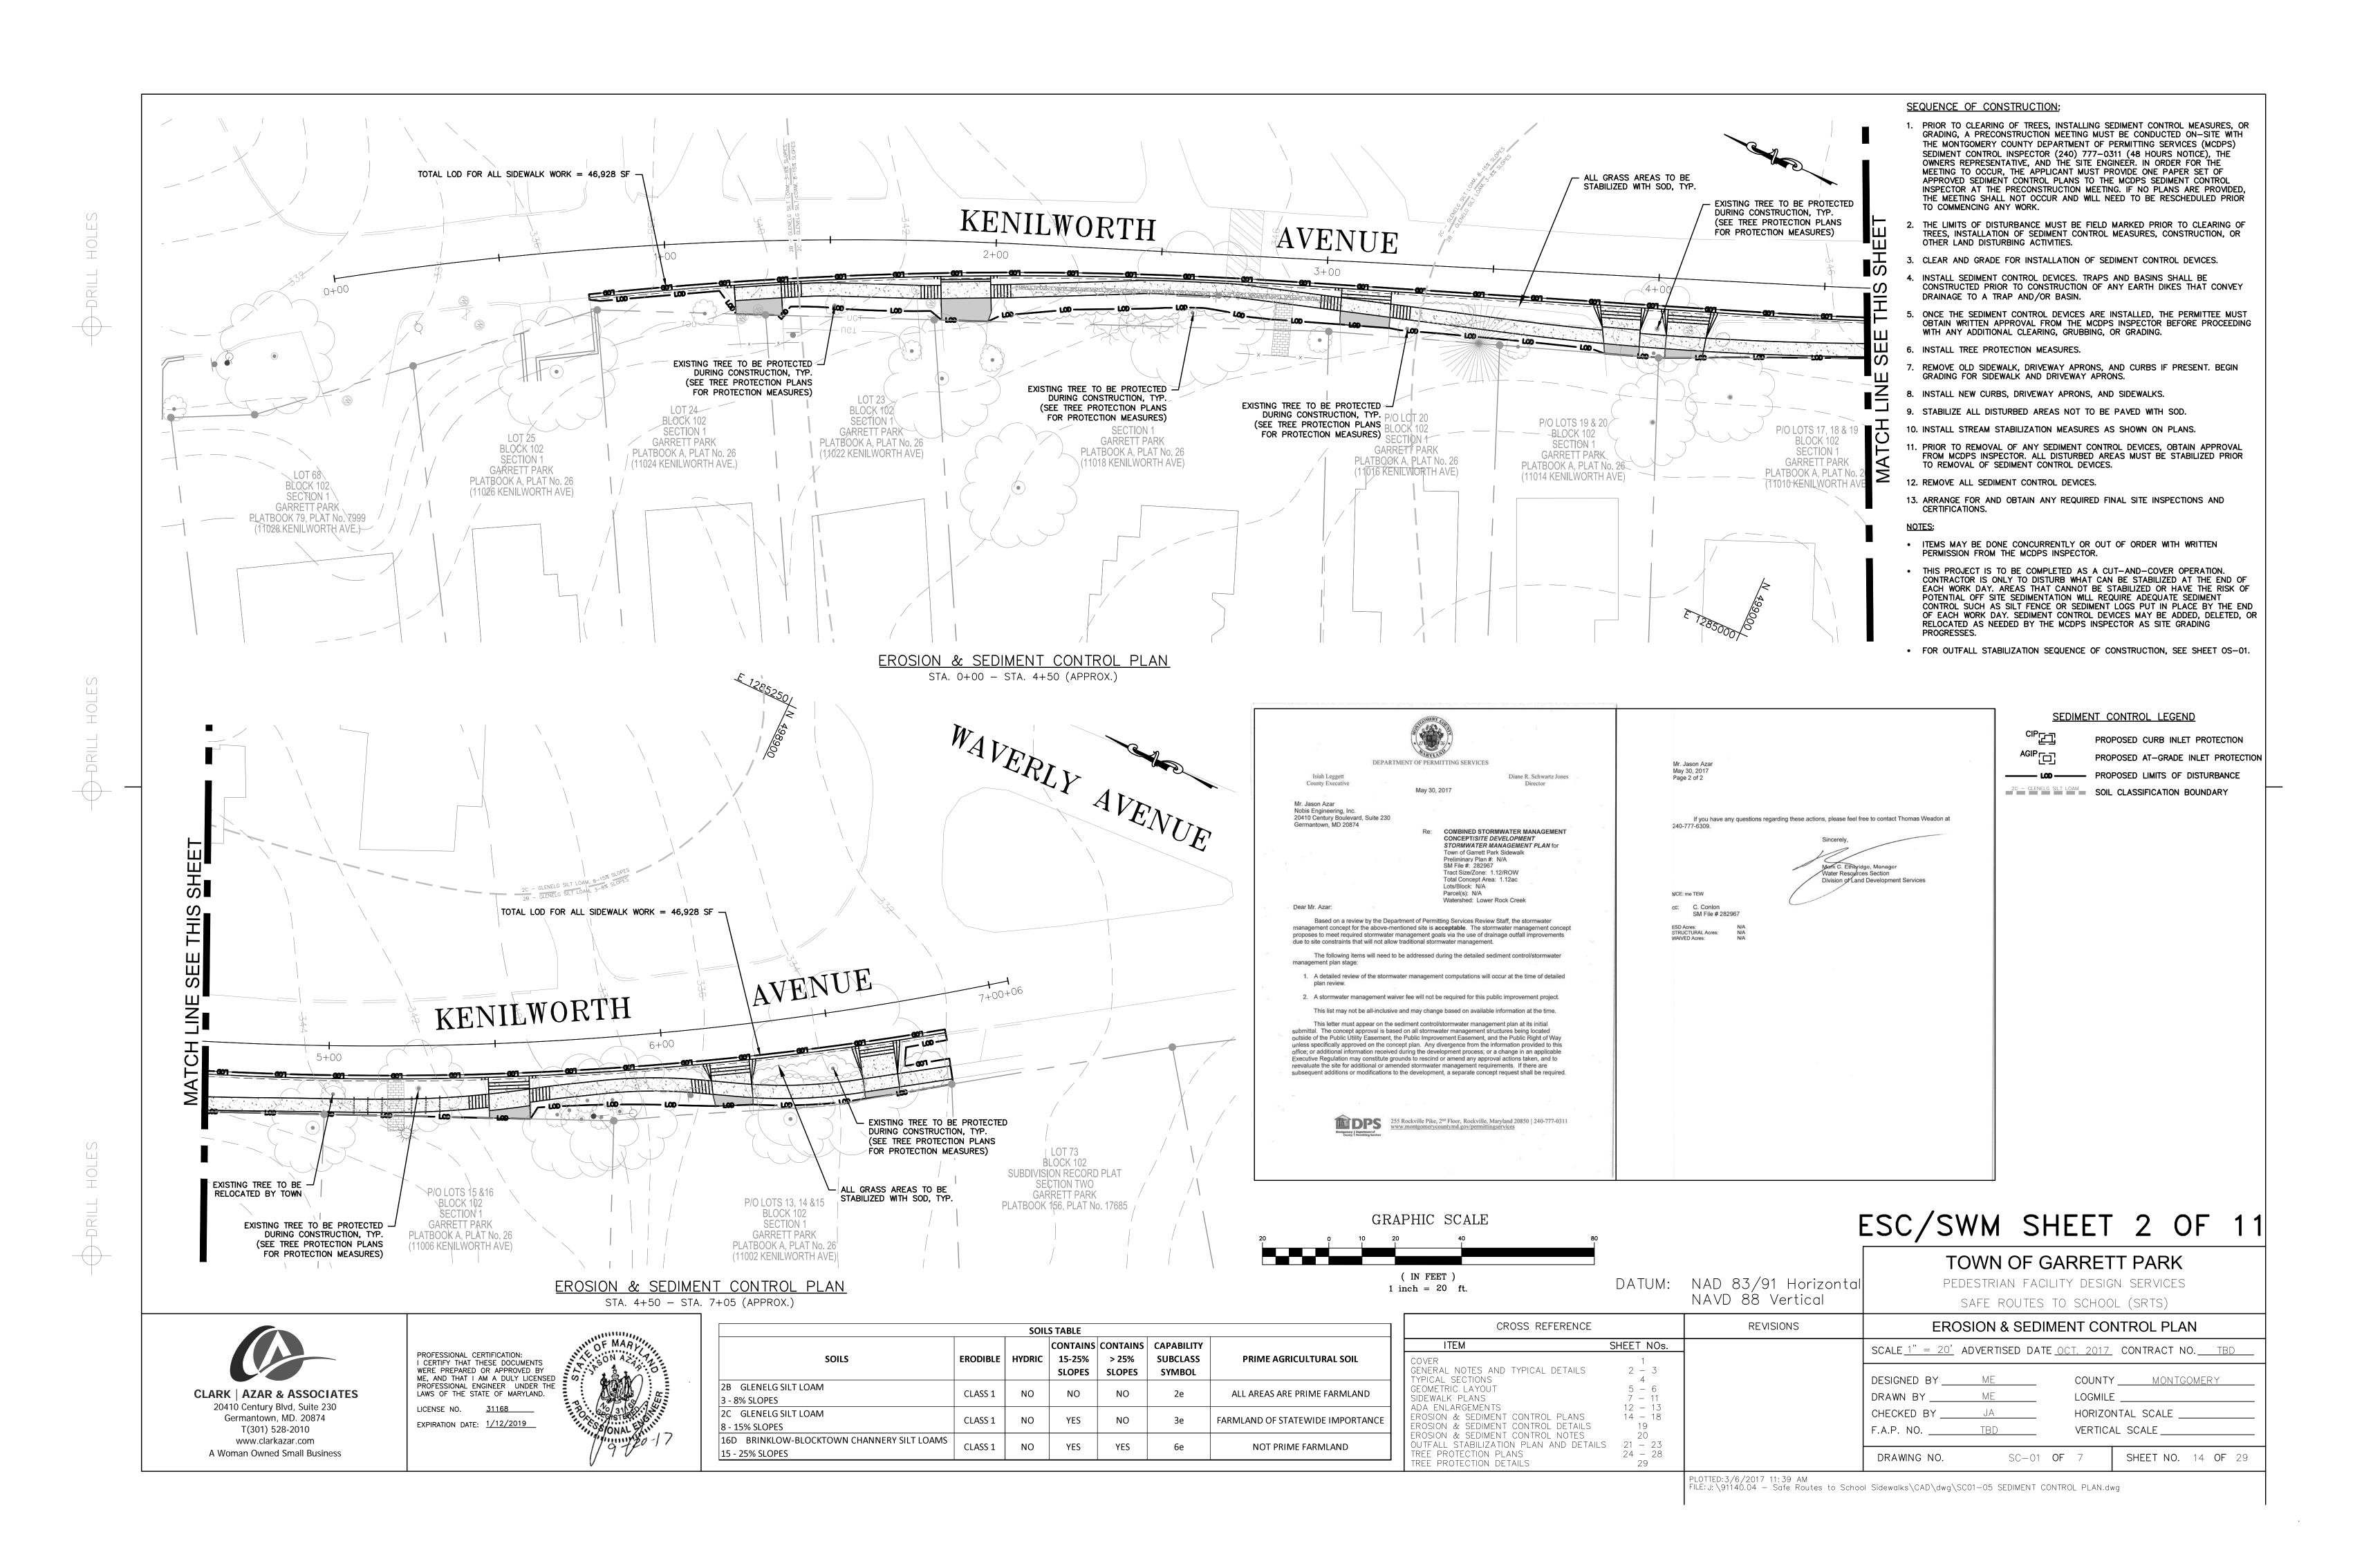


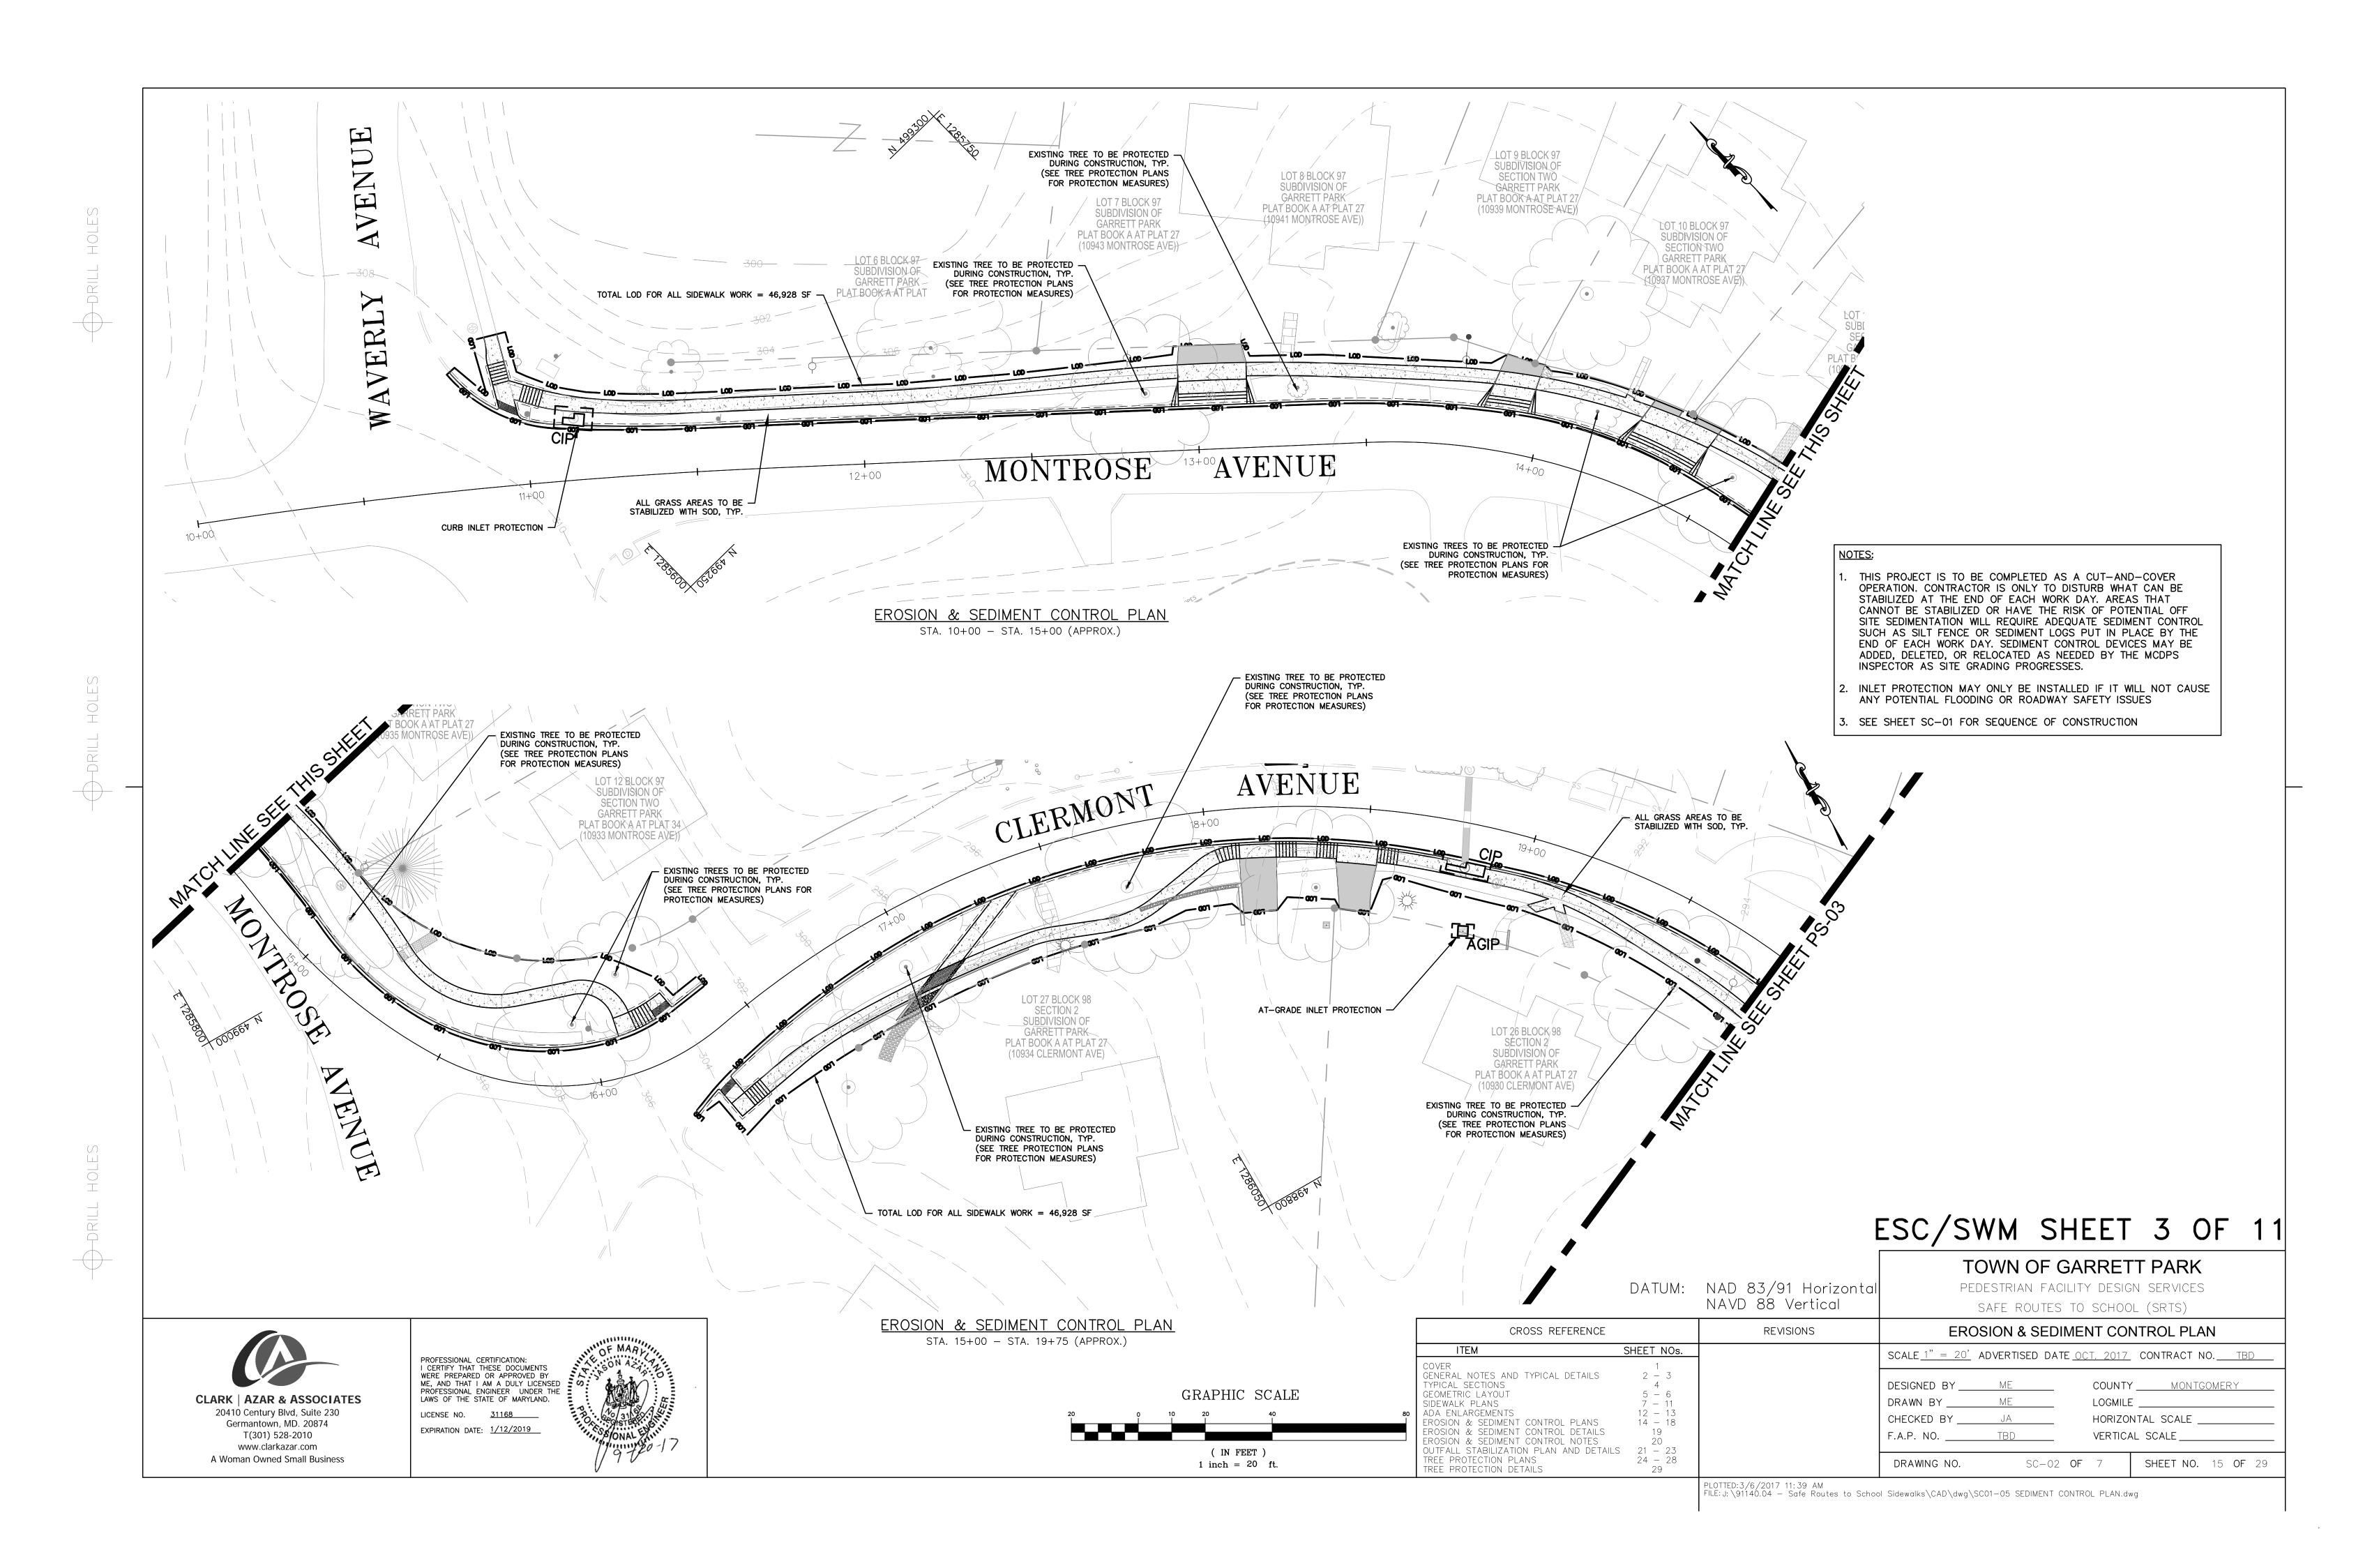


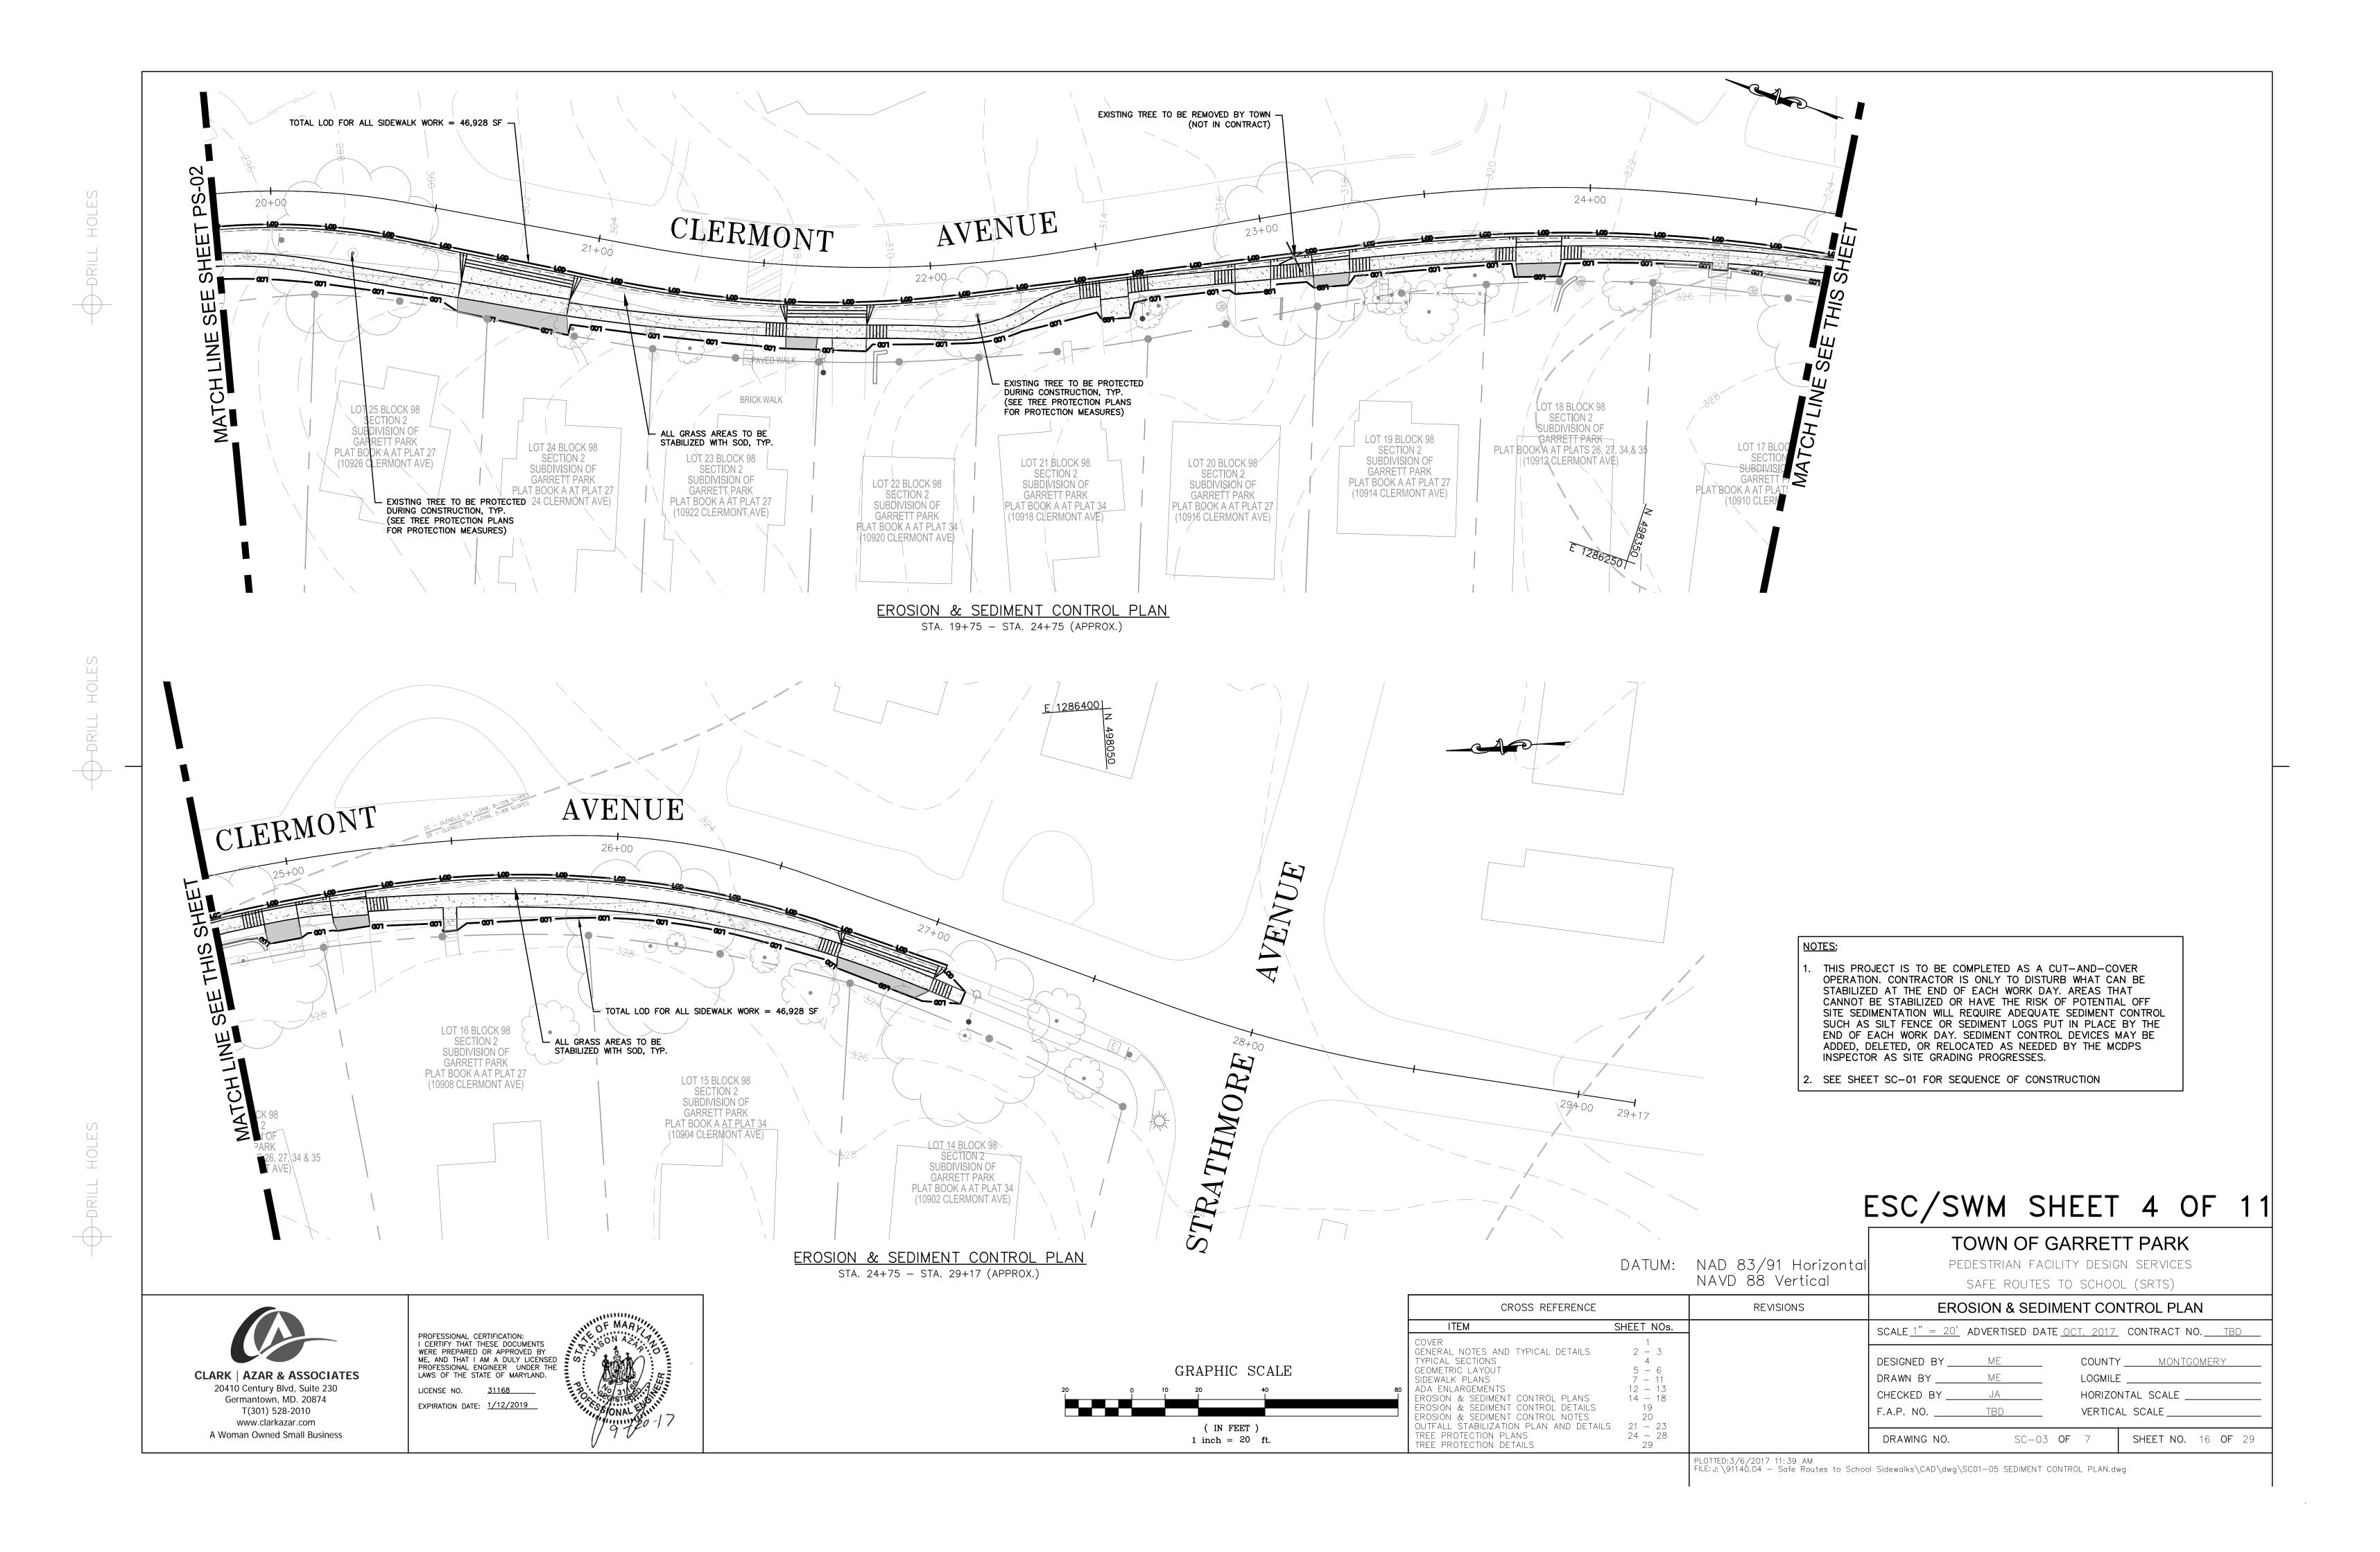

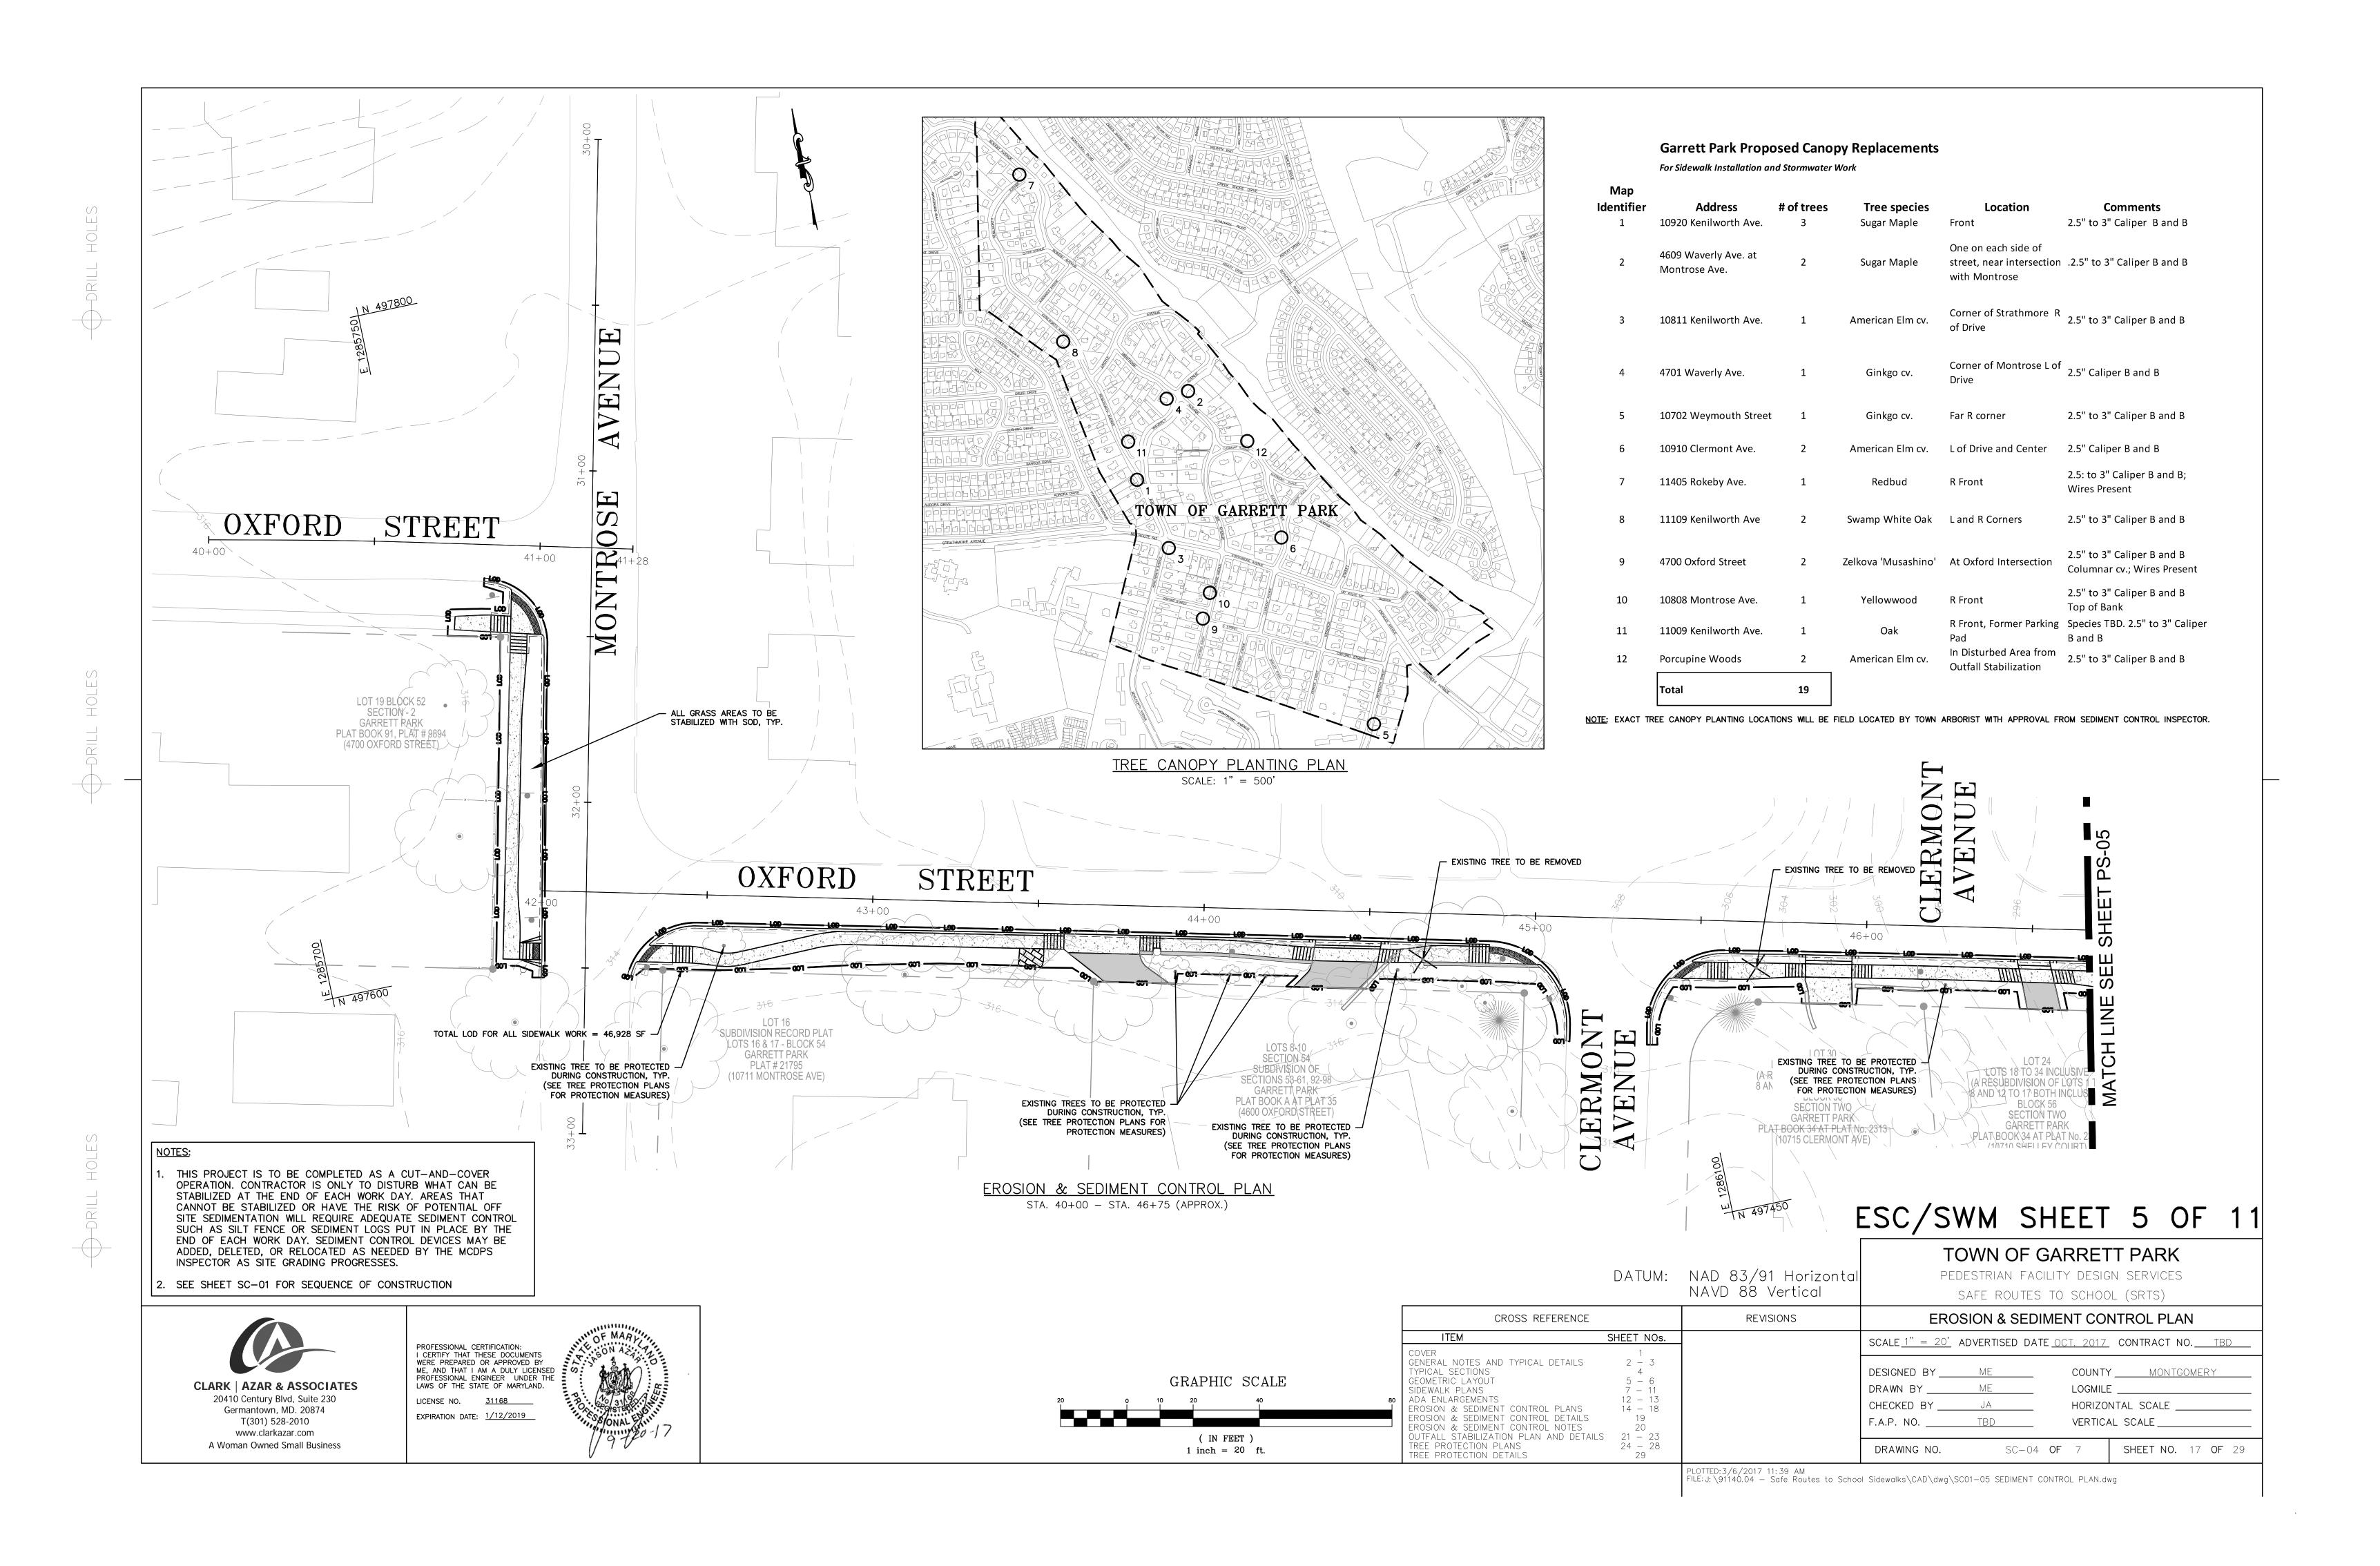

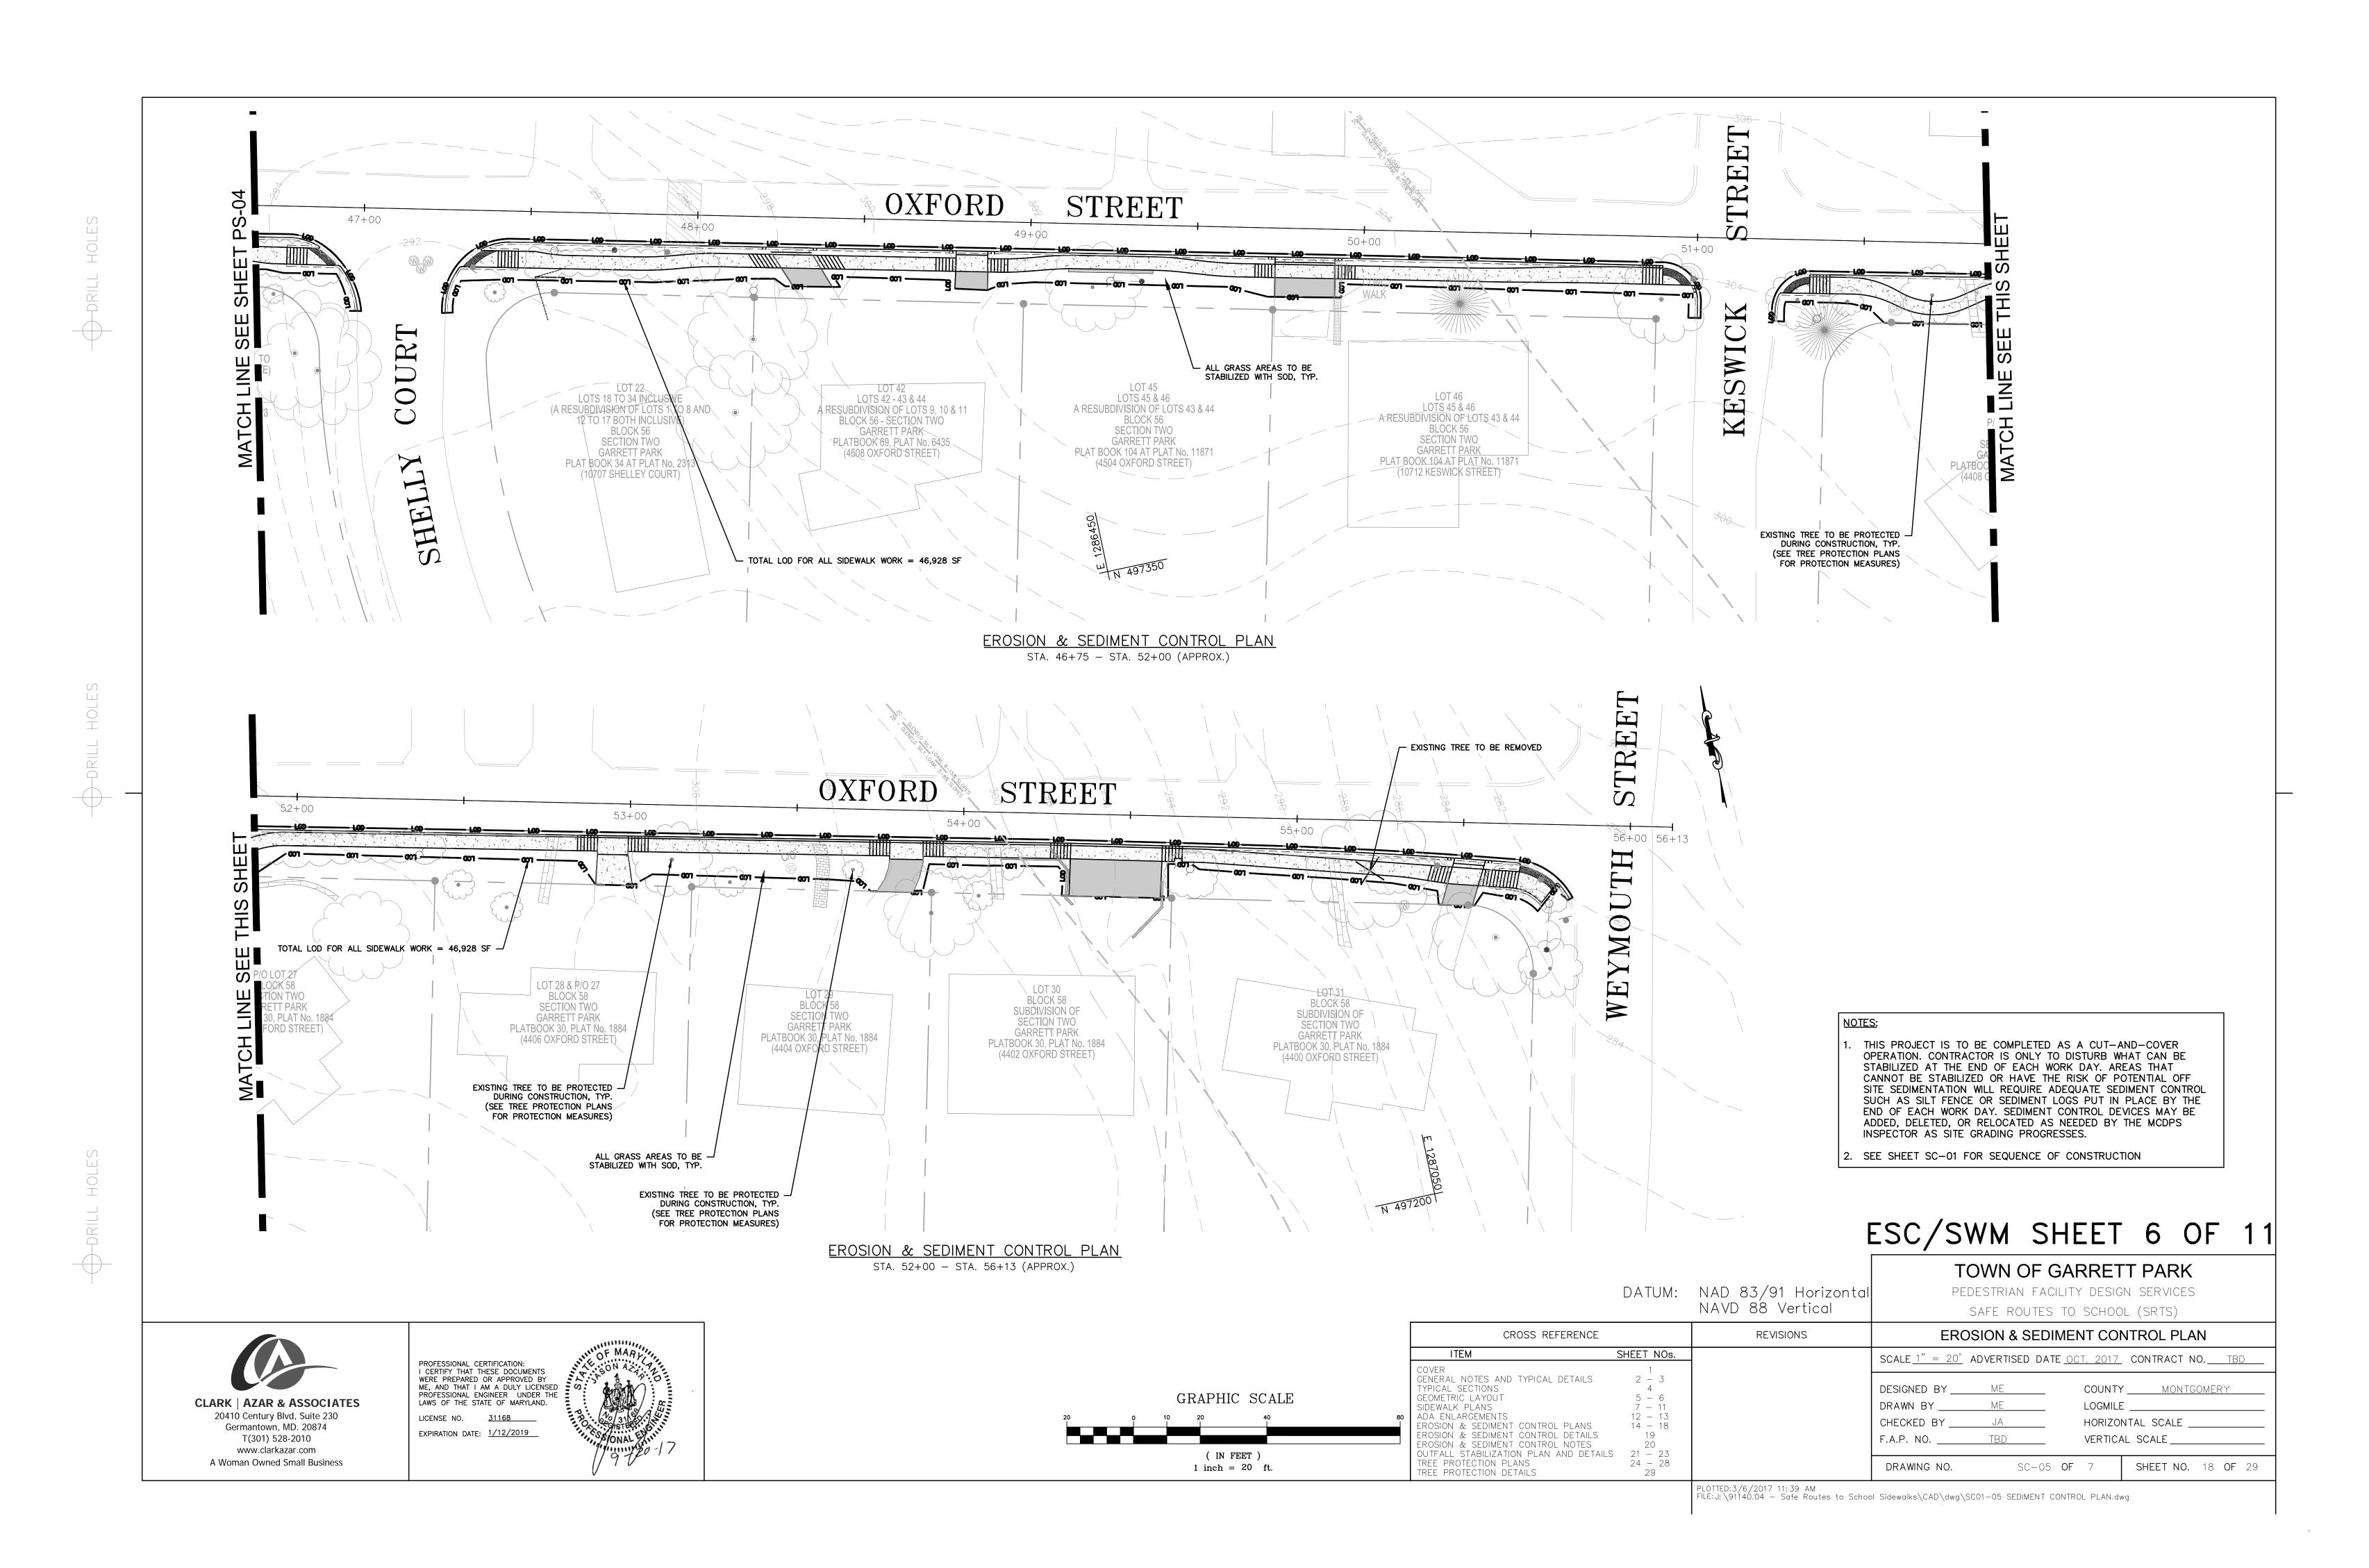

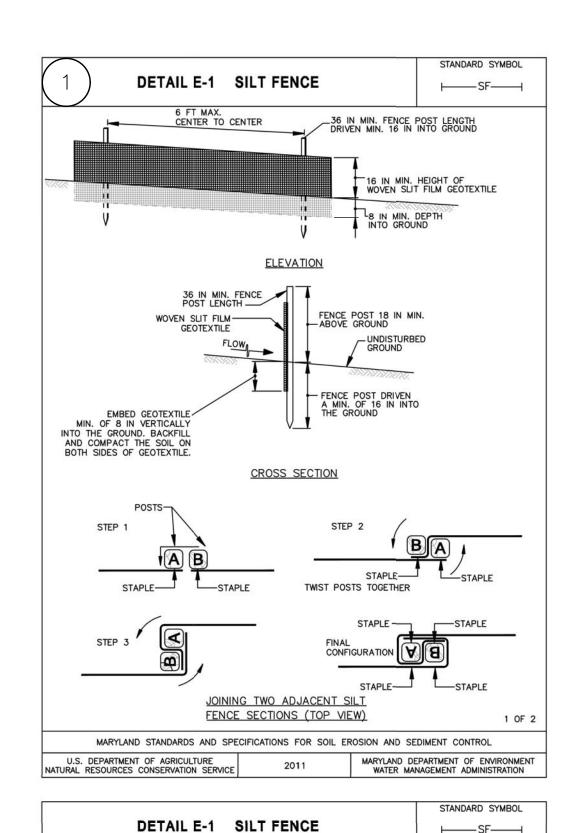


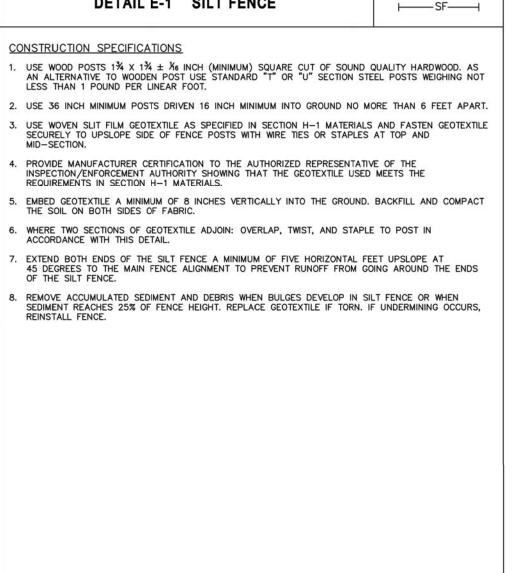

MARYLAND STANDARDS AND SPECIFICATIONS FOR SOIL EROSION AND SEDIMENT CONTROL


U.S. DEPARTMENT OF AGRICULTURE NATURAL RESOURCES CONSERVATION SERVICE 2 OF 2


MARYLAND DEPARTMENT OF ENVIRONMENT WATER MANAGEMENT ADMINISTRATION

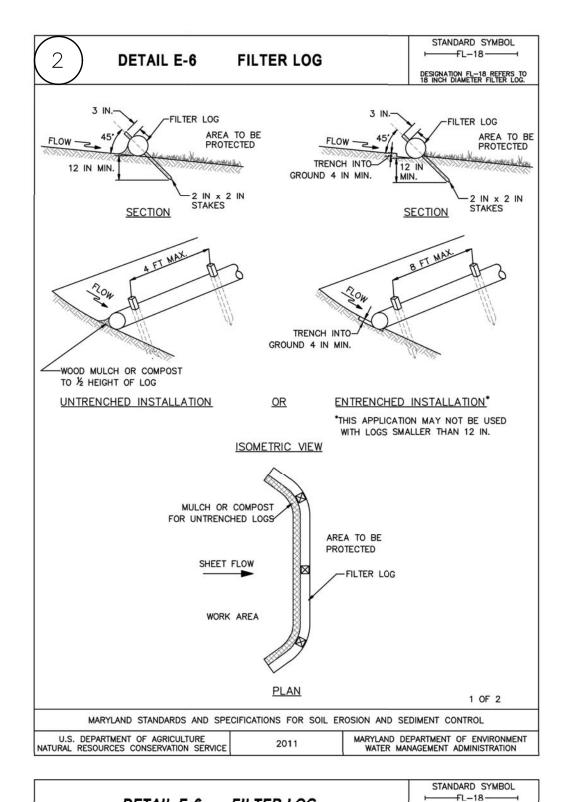



	DETAIL E-0 TIETER E00	DESIGNATION FL-18 REFERS TO 18 INCH DIAMETER FILTER LOG.
CC	NSTRUCTION SPECIFICATIONS	
1.	PRIOR TO INSTALLATION, CLEAR ALL OBSTRUCTIONS INCLUDING ROCKS, CLODS THAN ONE INCH THAT MAY INTERFERE WITH PROPER FUNCTION OF FILTER LO	
2.	FILL LOG NETTING UNIFORMLY WITH COMPOST (IN ACCORDANCE WITH SECTION OTHER APPROVED BIODEGRADABLE MATERIAL TO DESIRED LENGTH SUCH THAT	I H-1 MATERIALS), OR T LOGS DO NOT DEFORM.
3.	INSTALL FILTER LOGS PERPENDICULAR TO THE FLOW DIRECTION AND PARALLE THE BEGINNING AND END OF THE INSTALLATION POINTING SLIGHTLY UP THE SHAPE AT EACH END TO PREVENT BYPASS.	
4.	FOR UNTRENCHED INSTALLATION BLOW OR HAND PLACE MULCH OR COMPOST SLOPE ALONG LOG.	ON UPHILL SIDE OF THE
5.	STAKE FILTER LOG EVERY 4 FEET OR CLOSER ALONG ENTIRE LENGTH OF LOG GROUND A MINIMUM OF 4 INCHES AND STAKE LOG EVERY 8 FEET OR CLOSE	
6.	USE STAKES WITH A MINIMUM NOMINAL CROSS SECTION OF 2X2 INCH AND O ATTAIN A MINIMUM OF 12 INCHES INTO THE GROUND AND 3 INCHES PROTRUIT	
7.	WHEN MORE THAN ONE LOG IS NEEDED, OVERLAP ENDS 12 INCHES MINIMUM	AND STAKE.
8.	REMOVE SEDIMENT WHEN IT HAS ACCUMULATED TO A DEPTH OF $\frac{1}{2}$ THE EXPOREDLACE MULCH. REPLACE FILTER LOG IF TORN. REINSTALL FILTER LOG IF UP DISLODGING OCCURS. REPLACE CLOGGED FILTER LOGS. FOR PERMANENT APPLICATION BLOWN MEET REQUIREMENTS FOR ADEQUATE VEGETATIVE ESTABLISHM SECTION B-4 VEGETATIVE STABILIZATION.	NDERMINING OR LICATIONS, ESTABLISH AND
		2 OF 2
	MARYLAND STANDARDS AND SPECIFICATIONS FOR SOIL EROSION AND SE	
encul	U.S. DEPARTMENT OF AGRICULTURE 2011 MARYLAND DE	PARTMENT OF ENVIRONMENT
ATU		NAGEMENT ADMINISTRATION

DETAIL E-6 FILTER LOG

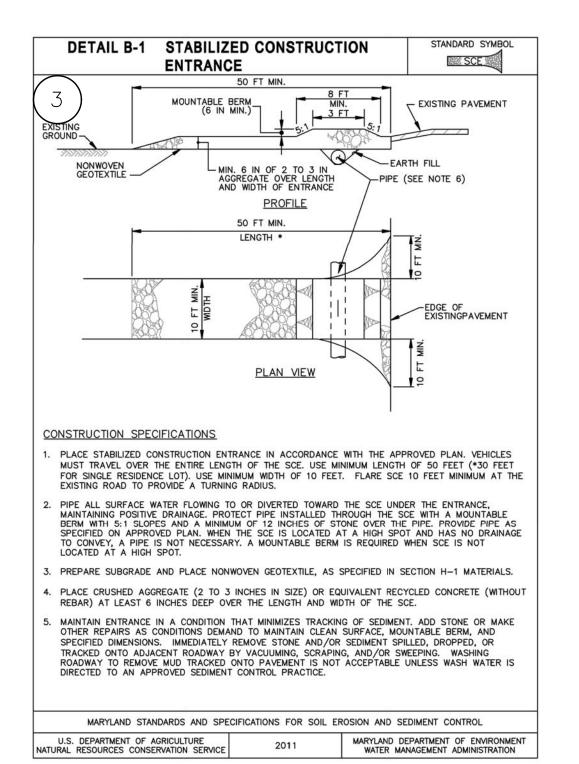

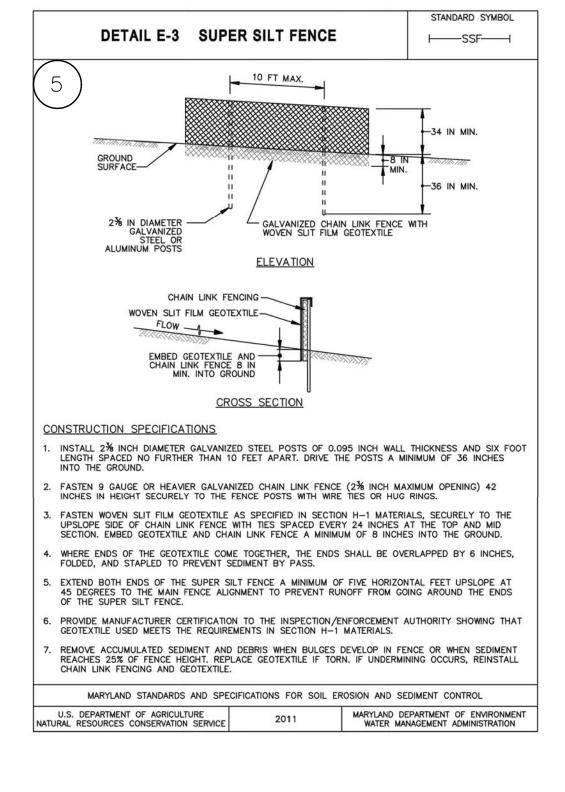

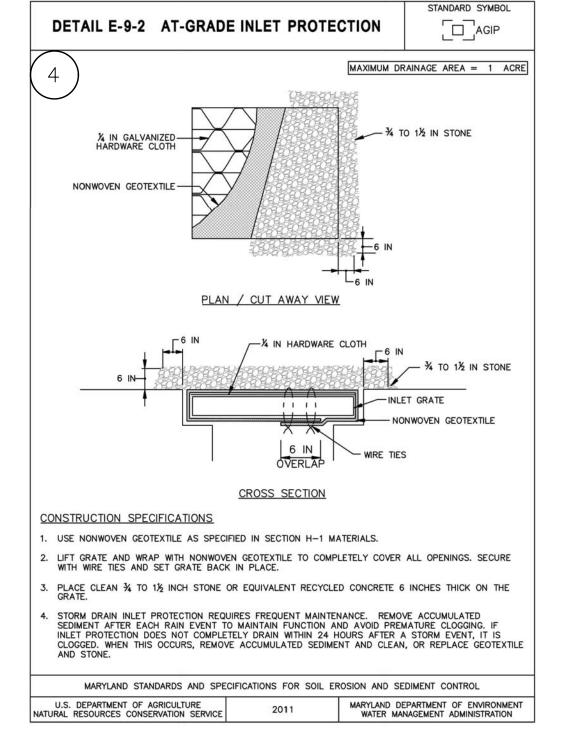

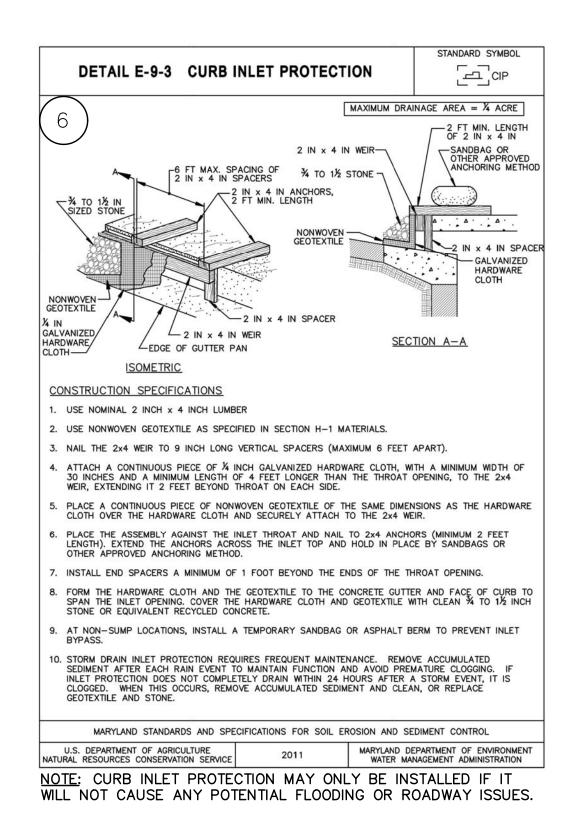

ESC/SWM SHEET 7 OF 11

DATUM: NAD 83/91 Horizontal NAVD 88 Vertical

TOWN OF GARRETT PARK PEDESTRIAN FACILITY DESIGN SERVICES



STANDARD EROSION AND SEDIMENT CONTROL NOTES

- THE PERMITTEE SHALL NOTIFY THE DEPARTMENT OF PERMITTING SERVICES (DPS) FORTY-EIGHT (48) HOURS BEFORE COMMENCING ANY LAND DISTURBING ACTIVITY AND, UNLESS WAIVED BY THE DEPARTMENT, SHALL BE REQUIRED TO HOLD A PRE-CONSTRUCTION MEETING BETWEEN THEM OR THEIR REPRESENTATIVE, THEIR ENGINEER AND AN AUTHORIZED REPRESENTATIVE OF THE DEPARTMENT.
- THE PERMITTEE MUST OBTAIN INSPECTION AND APPROVAL BY DPS AT THE FOLLOWING POINTS:
- A. AT THE REQUIRED PRE-CONSTRUCTION MEETING. B. FOLLOWING INSTALLATION OF SEDIMENT CONTROL MEASURES AND PRIOR TO ANY OTHER LAND DISTURBING
- C. DURING THE INSTALLATION OF A SEDIMENT BASIN OR STORMWATER MANAGEMENT STRUCTURE AT THE REQUIRED INSPECTION POINTS (SEE INSPECTION CHECKLIST ON PLAN). NOTIFICATION PRIOR TO COMMENCING CONSTRUCTION
- PRIOR TO REMOVAL OR MODIFICATION OF ANY SEDIMENT CONTROL STRUCTURE(S). PRIOR TO FINAL ACCEPTANCE.
- 3. THE PERMITTEE SHALL CONSTRUCT ALL EROSION AND SEDIMENT CONTROL MEASURES PER THE APPROVED PLAN AND CONSTRUCTION SEQUENCE, SHALL HAVE THEM INSPECTED AND APPROVED BY THE DEPARTMENT PRIOR TO BEGINNING ANY OTHER LAND DISTURBANCES, SHALL ENSURE THAT ALL RUNOFF FROM DISTURBED AREAS IS RECTED TO THE SEDIMENT CONTROL DEVICES, AND SHALL NOT REMOVE ANY EROSION OR SEDIMENT CONTROL
- THE PERMITTEE SHALL PROTECT ALL POINTS OF CONSTRUCTION INGRESS AND EGRESS TO PREVENT THE DEPOSITION OF MATERIALS ONTO TRAVERSED PUBLIC THOROUGHFARE(S). ALL MATERIALS DEPOSITED ONTO PUBLIC
- 5. THE PERMITTEE SHALL INSPECT PERIODICALLY AND MAINTAIN CONTINUOUSLY IN EFFECTIVE OPERATING CONDITION, ALL EROSION AND SEDIMENT CONTROL MEASURES UNTIL SUCH TIME AS THEY ARE REMOVED WITH PRIOR PERMISSION FROM THE DEPARTMENT. THE PERMITTEE IS RESPONSIBLE FOR IMMEDIATELY REPAIRING OR REPLACING ANY SEDIMENT CONTROL MEASURES WHICH HAVE BEEN DAMAGED OR REMOVED BY THE PERMITTEE OR ANY
- 6. FOLLOWING INITIAL SOIL DISTURBANCE OR RE-DISTURBANCE, PERMANENT OR TEMPORARY STABILIZATION MUST BE A) THREE (3) CALENDAR DAYS AS TO THE SURFACE OF ALL PERIMETER DIKES, SWALES, DITCHES, PERIMETER
- SLOPES AND ALL SLOPES STEEPER THAN 3 HORIZONTAL TO 1 VERTICAL (3:1); AND B) SEVEN (7) CALENDAR DAYS AS TO ALL OTHER DISTURBED OR GRADED AREAS ON THE PROJECT SITE NOT UNDER ACTIVE GRADING. ALL AREAS DISTURBED OUTSIDE OF THE PERIMETER SEDIMENT CONTROL SYSTEM MUST BE MINIMIZED AND STABILIZED IMMEDIATELY. MAINTENANCE MUST BE PERFORMED AS NECESSARY TO ENSURE
- 7. THE PERMITTEE SHALL APPLY SOD, SEED, AND ANCHORED STRAW MULCH, OR OTHER APPROVED STABILIZATION MEASURES TO ALL DISTURBED AREAS WITHIN SEVEN (7) CALENDAR DAYS AFTER STRIPPING AND GRADING ACTIVITIES HAVE CEASED ON THAT AREA. MAINTENANCE SHALL BE PERFORMED AS NECESSARY TO ENSURE CONTINUED STABILIZATION. ACTIVE CONSTRUCTION AREAS SUCH AS BORROW OR STOCKPILE AREAS, ROADWAY IMPROVEMENTS, AND AREAS WITHIN FIFTY (50) FEET OF A BUILDING UNDER CONSTRUCTION MAY BE EXEMPT FROM THIS REQUIREMENT, PROVIDED THAT ERÓSION AND SEDIMENT CONTROL MEASURES ARE INSTALLED AND
- B. PRIOR TO REMOVAL OF SEDIMENT CONTROL MEASURES, THE PERMITTEE SHALL STABILIZE ALL CONTRIBUTORY DISTURBED AREAS WITH REQUIRED SOIL AMENDMENTS AND TOPSOIL. USING SOD OR AN APPROVED PERMANENT SEED MIXTURE AND AN APPROVED ANCHORED MULCH, WOOD FIBER MULCH MAY ONLY BE USED IN SEEDING SEASON WHEN THE SLOPE DOES NOT EXCEED 10% AND GRADING HAS BEEN DONE TO PROMOTE SHEET FLOW DRAINAGE. AREAS BROUGHT TO FINISHED GRADE DURING THE SEEDING SEASON SHALL BE PERMANENTLY STABILIZED WITHIN SEVEN (7) CALENDAR DAYS OF ESTABLISHMENT. WHEN PROPERTY IS BROUGHT TO FINISHED GRADE DURING THE MONTHS OF NOVEMBER THROUGH FEBRUARY, AND PERMANENT STABILIZATION IS FOUND TO IMPRACTICAL, AN APPROVED TEMPORARY SEED AND STRAW ANCHORED MULCH SHALL BE APPLIED TURBED AREAS. THE FINAL PERMANENT STABILIZATION OF SUCH PROPERTY SHALL BE COMPLETED PRIOR TO
- 9. THE SITE PERMIT, WORK, MATERIALS, APPROVED SC/SM PLANS, AND TEST REPORTS SHALL BE AVAILABLE AT THE SITE FOR INSPECTION BY DULY AUTHORIZED OFFICIALS OF MONTGOMERY COUNTY.
- 10. SURFACE DRAINAGE FLOWS OVER UNSTABILIZED CUT AND FILL SLOPES SHALL BE CONTROLLED BY EITHER PREVENTING DRAINAGE FLOWS FROM TRAVERSING THE SLOPES OR BY INSTALLING MECHANICAL DEVICES TO LOWER THE WATER DOWN SLOPE WITHOUT CAUSING EROSION. DIKES SHALL BE INSTALLED AND MAINTAINED AT THE TOP OF CUT OR FILL SLOPES UNTIL THE SLOPE AND DRAINAGE AREA TO IT ARE FULLY STABILIZED, AT WHICH TIME THEY MUST BE REMOVED AND FINAL GRADING DONE TO PROMOTE SHEET FLOW DRAINAGE. MECHANICAL DEVICES MUST BE PROVIDED AT POINTS OF CONCENTRATED FLOW WHERE EROSION IS LIKELY TO OCCUR
- 1. PERMANENT SWALES OR OTHER POINTS OF CONCENTRATED WATER FLOW SHALL BE STABILIZED WITHIN 3 CALENDAR DAYS OF ESTABLISHMENT WITH SOD OR SEED WITH AN APPROVED EROSION CONTROL MATTING OR BY
- 12. SEDIMENT CONTROL DEVICES SHALL BE REMOVED, WITH PERMISSION OF THE DEPARTMENT, WITHIN THIRTY (30) CALENDAR DAYS FOLLOWING ESTABLISHMENT OF PERMANENT STABILIZATION IN ALL CONTRIBUTORY DRAINAGE AREAS. STORMWATER MANAGEMENT STRUCTURES USED TEMPORARILY FOR SEDIMENT CONTROL SHALL BE CONVERTED TO THE PERMANENT CONFIGURATION WITHIN THIS TIME PERIOD AS WELL.
- 13. NO PERMANENT CUT OR FILL SLOPE WITH A GRADIENT STEEPER THAN 3:1 WILL BE PERMITTED IN LAWN MAINTENANCE AREAS OR ON RESIDENTIAL LOTS. A SLOPE GRADIENT OF UP TO 2:1 WILL BE PERMITTED IN NONMAINTENANCE AREAS PROVIDED THAT THOSE AREAS ARE INDICATED ON THE EROSION AND SEDIMENT CONTROL PLAN WITH A LOW-MAINTENANCE GROUND COVER SPECIFIED FOR PERMANENT STABILIZATION. SLOPE GRADIENT STEEPER THAN 2:1 WILL NOT BE PERMITTED WITH VEGETATIVE STABILIZATION
- 4. THE PERMITTEE SHALL INSTALL A SPLASHBLOCK AT THE BOTTOM OF EACH DOWNSPOUT UNLESS THE DOWNSPOUT IS CONNECTED BY A DRAIN LINE TO AN ACCEPTABLE OUTLET.
- 15. FOR FINISHED GRADING, THE PERMITTEE SHALL PROVIDE ADEQUATE GRADIENTS SO AS TO PREVENT WATER FROM STANDING ON THE SURFACE OF LAWNS MORE THAN TWENTY-FOUR (24) HOURS AFTER THE END OF A RAINFALL, EXCEPT IN DESIGNATED DRAINAGE COURSES AND SWALE FLOW AREAS, WHICH MAY DRAIN AS LONG AS FORTY-EIGHT (48) HOURS AFTER THE END OF A RAINFALL.
- 16. SEDIMENT TRAPS OR BASINS ARE NOT PERMITTED WITHIN 20 FEET OF A BUILDING WHICH IS EXISTING OR UNDER CONSTRUCTION. NO BUILDING MAY BE CONSTRUCTED WITHIN 20 FEET OF A SEDIMENT TRAP OR BASIN.
- 17. ALL INLETS IN NON-SUMP AREAS SHALL HAVE ASPHALT BERMS INSTALLED AT THE TIME OF BASE PAVING ESTABLISHMENT.
- 18. THE SEDIMENT CONTROL INSPECTOR HAS THE OPTION OF REQUIRING ADDITIONAL SEDIMENT CONTROL MEASURES,
- 19. ALL TRAP ELEVATIONS ARE RELATIVE TO THE OUTLET ELEVATION, WHICH MUST BE ON EXISTING UNDISTURBED
- 20. VEGETATIVE STABILIZATION SHALL BE PERFORMED IN ACCORDANCE WITH THE STANDARDS AND SPECIFICATIONS FOR SOIL EROSION AND SEDIMENT CONTROL. 21. SEDIMENT TRAP(S)/BASIN(S) SHALL BE CLEANED OUT AND RESTORED TO THE ORIGINAL DIMENSIONS WHEN SEDIMENT HAS ACCUMULATED TO THE POINT OF ONE-HALF (1/2) THE WET STORAGE DEPTH OF THE TRAP/BASIN
- (1/4 THE WET STORAGE DEPTH FOR ST-III) OR WHEN REQUIRED BY THE SEDIMENT CONTROL INSPECTOR. 22. SEDIMENT REMOVED FROM TRAPS/BASINS SHALL BE PLACED AND STABILIZED IN APPROVED AREAS, BUT NOT WITHIN A FLOODPLAIN.
- 23. ALL SEDIMENT BASINS AND TRAPS MUST BE SURROUNDED WITH A WELDED WIRE SAFETY FENCE. THE FENCE MUST BE AT LEAST 42 INCHES HIGH, HAVE POSTS SPACED NO FARTHER APART THAN 8 FEET, HAVE MESH OPENINGS NO GREATER THE TWO INCHES IN WIDTH AND FOUR INCHES IN HEIGHT, WITH A MINIMUM OF 14 GAUGE MRE. SAFETY FENCE MUST BE MAINTAINED IN GOOD CONDITION AT ALL TIMES.
- 24. NO EXCAVATION IN THE AREAS OF EXISTING UTILITIES IS PERMITTED UNLESS THEIR LOCATION HAS BEEN DETERMINED. CALL "MISS UTILITY" AT 1-800-257-7777, 48 HOURS PRIOR TO THE START OF WORK.
- 25. OFF-SITE SPOIL OR BORROW AREAS MUST HAVE PRIOR APPROVAL BY DPS. 26. SEDIMENT TRAP/BASIN DEWATERING FOR CLEANOUT OR REPAIR MAY ONLY BE DONE WITH THE DPS INSPECTOR'S PERMISSION. THE INSPECTOR MUST APPROVE THE DEWATERING METHOD FOR EACH APPLICATION. THE FOLLOWING
- A. PUMP DISCHARGE MAY BE DIRECTED TO ANOTHER ON-SITE SEDIMENT TRAP OR BASIN, PROVIDED IT IS OF SUFFICIENT VOLUME AND THE PUMP INTAKE IS FLOATED TO PREVENT AGITATION OR SUCTION OF DEPOSITED
- B. THE PUMP INTAKE MAY UTILIZE A REMOVABLE PUMPING STATION AND MUST DISCHARGE INTO AN UNDISTURBED AREA THROUGH A NON-EROSIVE OUTLET; OR
- C. THE PUMP INTAKE MAY BE FLOATED AND DISCHARGE INTO A DIRT BAG (12 OZ. NON-WOVEN FABRIC), OR APPROVED EQUIVALENT, LOCATED IN AN UNDISTURBED BUFFER AREA.
- REMEMBER: DEWATERING OPERATION AND METHOD MUST HAVE PRIOR APPROVAL BY THE DPS INSPECTOR.
- 27. THE PERMITTEE MUST NOTIFY THE DEPARTMENT OF ALL UTILITY CONSTRUCTION ACTIVITIES WITHIN THE PERMITTED LIMITS OF DISTURBANCE PRIOR TO THE COMMENCEMENT OF THOSE ACTIVITIES.
- 28. TOPSOIL MUST BE APPLIED TO ALL PERVIOUS AREAS WITHIN THE LIMITS OF DISTURBANCE PRIOR TO PERMANENT STABILIZATION IN ACCORDANCE WITH MDE "STANDARDS AND SPECIFICATIONS FOR SOIL PREPARATION, TOPSOILING,

SOIL PREPARATION, TOPSOILING, AND SOIL AMENDMENTS

A. SOIL PREPARATION

1. TEMPORARY STABILIZATION

A. SEEDBED PREPARATION CONSISTS OF LOOSENING SOIL TO A DEPTH OF 3 TO 5 INCHES BY MEANS OF SUITABLE AGRICULTURAL OR CONSTRUCTION EQUIPMENT, SUCH AS DISC HARROWS OR CHISEL PLOWS OR RIPPERS MOUNTED ON CONSTRUCTION EQUIPMENT. AFTER THE SOIL IS LOOSENED, IT MUST NOT BE ROLLED OR DRAGGED SMOOTH BUT LEFT IN THE ROUGHENED CONDITION. SLOPES 3:1 OR FLATTER ARE TO BE TRACKED WITH RIDGES RUNNING PARALLEL TO THE CONTOUR OF THE SLOPE.

B. APPLY FERTILIZER AND LIME AS PRESCRIBED ON THE PLANS.

C. INCORPORATE LIME AND FERTILIZER INTO THE TOP 3 TO 5 INCHES OF SOIL BY DISKING OR OTHER SUITABLE MEANS. 2. PERMANENT STABILIZATION

- A. A SOIL TEST IS REQUIRED FOR ANY EARTH DISTURBANCE OF 5 ACRES OR MORE. THE CONDITIONS REQUIRED FOR PERMANENT VEGETATIVE ESTABLISHMENT ARE:
- I. SOIL PH BETWEEN 6.0 AND 7.0.

UNNECESSARY ON NEWLY DISTURBED AREAS.

THE ABOVE CONDITIONS.

- II. SOLUBLE SALTS LESS THAN 500 PARTS PER MILLION (PPM).
- III. SOIL CONTAINS LESS THAN 40 PERCENT CLAY BUT ENOUGH FINE GRAINED MATERIAL (GREATER THAN 30 PERCENT SILT PLUS CLAY) TO PROVIDE THE CAPACITY TO HOLD A MODERATE AMOUNT OF MOISTURE. AN EXCEPTION: IF LOVEGRASS WILL BE PLANTED, THEN A SANDY SOIL (LESS THAN 30 PERCENT SILT PLUS CLAY) WOULD BE
- IV. SOIL CONTAINS 1.5 PERCENT MINIMUM ORGANIC MATTER BY WEIGHT.
- V. SOIL CONTAINS SUFFICIENT PORE SPACE TO PERMIT ADEQUATE ROOT PENETRATION. B. APPLICATION OF AMENDMENTS OR TOPSOIL IS REQUIRED IF ON-SITE SOILS DO NOT MEET
- C. GRADED AREAS MUST BE MAINTAINED IN A TRUE AND EVEN GRADE AS SPECIFIED ON THE APPROVED PLAN, THEN SCARIFIED OR OTHERWISE LOOSENED TO A DEPTH OF 3 TO 5
- D. APPLY SOIL AMENDMENTS AS SPECIFIED ON THE APPROVED PLAN OR AS INDICATED BY THE RESULTS OF A SOIL TEST.
- E. MIX SOIL AMENDMENTS INTO THE TOP 3 TO 5 INCHES OF SOIL BY DISKING OR OTHER SUITABLE MEANS. RAKE LAWN AREAS TO SMOOTH THE SURFACE, REMOVE LARGE OBJECTS LIKE STONES AND BRANCHES, AND READY THE AREA FOR SEED APPLICATION. LOOSEN SURFACE SOIL BY DRAGGING WITH A HEAVY CHAIN OR OTHER EQUIPMENT TO ROUGHEN THE SURFACE WHERE SITE CONDITIONS WILL NOT PERMIT NORMAL SEEDBED PREPARATION. TRACK SLOPES 3:1 OR FLATTER WITH TRACKED EQUIPMENT LEAVING THE SOIL IN AN IRREGULAR CONDITION WITH RIDGES RUNNING PARALLEL TO THE CONTOUR OF THE SLOPE. LEAVE THE TOP 1 TO 3 INCHES OF SOIL LOOSE AND FRIABLE. SEEDBED LOOSENING MAY BE

VEGETATION. THE PURPOSE IS TO PROVIDE A SUITABLE SOIL MEDIUM FOR VEGETATIVE GROWTH. SOILS OF CONCERN HAVE LOW MOISTURE CONTENT, LOW NUTRIENT LEVELS, LOW PH, MATERIALS TOXIC TO PLANTS, AND/OR UNACCEPTABLE SOIL GRADATION.

2. TOPSOIL SALVAGED FROM AN EXISTING SITE MAY BE USED PROVIDED IT MEETS THE STANDARDS AS SET FORTH IN THESE SPECIFICATIONS. TYPICALLY, THE DEPTH OF TOPSOIL TO BE SALVAGED FOR A GIVEN SOIL TYPE CAN BE FOUND IN THE REPRESENTATIVE SOIL PROFILE SECTION IN THE SOIL SURVEY PUBLISHED BY USDA-NRCS.

3. TOPSOILING IS LIMITED TO AREAS HAVING 2:1 OR FLATTER SLOPES WHERE:

A. THE TEXTURE OF THE EXPOSED SUBSOIL/PARENT MATERIAL IS NOT ADEQUATE TO PRODUCE VEGETATIVE GROWTH.

- B. THE SOIL MATERIAL IS SO SHALLOW THAT THE ROOTING ZONE IS NOT DEEP ENOUGH T SUPPORT PLANTS OR FURNISH CONTINUING SUPPLIES OF MOISTURE AND PLANT NUTRIENTS. C. THE ORIGINAL SOIL TO BE VEGETATED CONTAINS MATERIAL TOXIC TO PLANT GROWTH. D. THE SOIL IS SO ACIDIC THAT TREATMENT WITH LIMESTONE IS NOT FEASIBLE.
- 4. AREAS HAVING SLOPES STEEPER THAN 2:1 REQUIRE SPECIAL CONSIDERATION AND DESIGN.
- 5. TOPSOIL SPECIFICATIONS: SOIL TO BE USED AS TOPSOIL MUST MEET THE FOLLOWING CRITERIA: A. TOPSOIL MUST BE A LOAM, SANDY LOAM, CLAY LOAM, SILT LOAM, SANDY CLAY LOAM, OR LOAMY SAND. OTHER SOILS MAY BE USED IF RECOMMENDED BY AN AGRONOMIST OR SOIL BE A MIXTURE OF CONTRASTING TEXTURED SUBSOILS AND MUST CONTAIN LESS THAN 5 PERCENT BY VOLUME OF CINDERS, STONES, SLAG, COARSE FRAGMENTS, GRAVEL, STICKS, ROOTS, TRASH, OR OTHER MATERIALS LARGER THAN 11/2 INCHES IN
- B. TOPSOIL MUST BE FREE OF NOXIOUS PLANTS OR PLANT PARTS SUCH AS BERMUDA GRASS, QUACK GRASS, JOHNSON GRASS, NUT SEDGE, POISON IVY, THISTLE, OR OTHERS AS
- C. TOPSOIL SUBSTITUTES OR AMENDMENTS, AS RECOMMENDED BY A QUALIFIED AGRONOMIST OR SOIL SCIENTIST AND APPROVED BY THE APPROPRIATE APPROVAL AUTHORITY, MAY BE USED IN LIEU OF NATURAL TOPSOIL.
- A. EROSION AND SEDIMENT CONTROL PRACTICES MUST BE MAINTAINED WHEN APPLYING
- B. UNIFORMLY DISTRIBUTE TOPSOIL IN A 5 TO 8 INCH LAYER AND LIGHTLY COMPACT TO A MINIMUM THICKNESS OF 4 INCHES. SPREADING IS TO BE PERFORMED IN SUCH A MANNER THAT SODDING OR SEEDING CAN PROCEED WITH A MINIMUM OF ADDITIONAL SOIL PREPARATION AND TILLAGE. ANY IRREGULARITIES IN THE SURFACE RESULTING FROM TOPSOILING OR OTHER OPERATIONS MUST BE CORRECTED IN ORDER TO PREVENT THE FORMATION OF DEPRESSIONS OR WATER POCKETS.
- C. TOPSOIL MUST NOT BE PLACED IF THE TOPSOIL OR SUBSOIL IS IN A FROZEN OR MUDDY CONDITION, WHEN THE SUBSOIL IS EXCESSIVELY WET OR IN A CONDITION THAT MAY OTHERWISE BE DETRIMENTAL TO PROPER GRADING AND SEEDBED PREPARATION.
- C. SOIL AMENDMENTS (FERTILIZER AND LIME SPECIFICATIONS)
- 1. SOIL TESTS MUST BE PERFORMED TO DETERMINE THE EXACT RATIOS AND APPLICATION RATES FOR BOTH LIME AND FERTILIZER ON SITES HAVING DISTURBED AREAS OF 5 ACRES OR MORE. SOIL ANALYSIS MAY BE PERFORMED BY A RECOGNIZED PRIVATE OR COMMERCIAL LABORATORY. SOIL SAMPLES TAKEN FOR ENGINEERING PURPOSES MAY ALSO BE USED FOR CHEMICAL ANALYSES.
- 2. FERTILIZERS MUST BE UNIFORM IN COMPOSITION, FREE FLOWING AND SUITABLE FOR ACCURATE APPLICATION BY APPROPRIATE EQUIPMENT. MANURE MAY BE SUBSTITUTED FOR FERTILIZER WITH PRIOR APPROVAL FROM THE APPROPRIATE APPROVAL AUTHORITY. FERTILIZERS MUST ALL BE DELIVERED TO THE SITE FULLY LABELED ACCORDING TO THE APPLICABLE LAWS AND MUST BEAR THE NAME, TRADE NAME OR TRADEMARK AND WARRANTY OF THE PRODUCER.
- 3. LIME MATERIALS MUST BE GROUND LIMESTONE (HYDRATED OR BURNT LIME MAY BE SUBSTITUTED EXCEPT WHEN HYDROSEEDING) WHICH CONTAINS AT LEAST 50 PERCENT TOTAL OXIDES (CALCIUM OXIDE PLUS MAGNESIUM OXIDE). LIMESTONE MUST BE GROUND TO SUCH FINENESS THAT AT LEAST 50 PERCENT WILL PASS THROUGH A #100 MESH SIEVE AND 98 TO 100 PERCENT WILL PASS THROUGH A #20 MESH SIEVE.
- 4. LIME AND FERTILIZER ARE TO BE EVENLY DISTRIBUTED AND INCORPORATED INTO THE TOP 3 TO 5 INCHES OF SOIL BY DISKING OR OTHER SUITABLE MEANS.
- 5. WHERE THE SUBSOIL IS EITHER HIGHLY ACIDIC OR COMPOSED OF HEAVY CLAYS, SPREAD GROUND LIMESTONE AT THE RATE OF 4 TO 8 TONS/ACRE (200-400 POUNDS PER 1,000 SQUARE FEET) PRIOR TO THE PLACEMENT OF TOPSOIL.

SEEDING AND MULCHING

A. ALL SEED MUST MEET THE REQUIREMENTS OF THE MARYLAND STATE SEED LAW. ALL SEED MUST BE SUBJECT TO RE-TESTING BY A RECOGNIZED SEED LABORATORY. ALL SEED USED MUST HAVE BEEN TESTED WITHIN THE 6 MONTHS IMMEDIATELY PRECEDING THE DATE OF SOWING SUCH MATERIAL ON ANY PROJECT. REFER TO TABLE B.4 REGARDING THE QUALITY OF SEED. SEED TAGS MUST BE AVAILABLE UPON REQUEST TO THE INSPECTOR TO VERIFY TYPE OF

B. MULCH ALONE MAY BE APPLIED BETWEEN THE FALL AND SPRING SEEDING DATES ONLY IF THE GROUND IS FROZEN. THE APPROPRIATE SEEDING MIXTURE MUST BE APPLIED WHEN THE

C. INOCULANTS: THE INOCULANT FOR TREATING LEGUME SEED IN THE SEED MIXTURES MUST BE A PURE CULTURE OF NITROGEN FIXING BACTERIA PREPARED SPECIFICALLY FOR THE SPECIES. INOCULANTS MUST NOT BE USED LATER THAN THE DATE INDICATED ON THE CONTAINER. AL FRESH INOCULANTS AS DIRECTED ON THE PACKAGE. USE FOUR TIMES THE RECOMMENDED RATE WHEN HYDROSEEDING. NOTE: IT IS VERY IMPORTANT TO KEEP INOCULANT AS COOL AS POSSIBLE UNTIL USED. TEMPERATURES ABOVE 75 TO 80 DEGREES FAHRENHEIT CAN WEAKEN BACTERIA AND MAKE THE INOCULANT LESS EFFECTIVE.

D. SOD OR SEED MUST NOT BE PLACED ON SOIL WHICH HAS BEEN TREATED WITH SOIL STERILANTS OR CHEMICALS USED FOR WEED CONTROL UNTIL SUFFICIENT TIME HAS ELAPSED (14 DAYS MIN.) TO PERMIT DISSIPATION OF PHYTO-TOXIC MATERIALS.

- A. DRY SEEDING: THIS INCLUDES USE OF CONVENTIONAL DROP OR BROADCAST SPREADERS. I. INCORPORATE SEED INTO THE SUBSOIL AT THE RATES PRESCRIBED ON TEMPORARY SEEDING TABLE B.1, PERMANENT SEEDING TABLE B.3, OR SITE—SPECIFIC SEEDING
- II. APPLY SEED IN TWO DIRECTIONS, PERPENDICULAR TO EACH OTHER. APPLY HALF THE SEEDING RATE IN EACH DIRECTION. ROLL THE SEEDED AREA WITH A WEIGHTED ROLLER TO PROVIDE GOOD SEED TO SOIL CONTACT.
- B. DRILL OR CULTIPACKER SEEDING: MECHANIZED SEEDERS THAT APPLY AND COVER SEED WITH
- I. CULTIPACKING SEEDERS ARE REQUIRED TO BURY THE SEED IN SUCH A FASHION AS TO PROVIDE AT LEAST 1/4 INCH OF SOIL COVERING. SEEDBED MUST BE FIRM AFTER
- II. APPLY SEED IN TWO DIRECTIONS, PERPENDICULAR TO EACH OTHER. APPLY HALF THE SEEDING RATE IN EACH DIRECTION. C. HYDROSEEDING: APPLY SEED UNIFORMLY WITH HYDROSEEDER (SLURRY INCLUDES SEED AND
- I. IF FERTILIZER IS BEING APPLIED AT THE TIME OF SEEDING, THE APPLICATION RATES SHOULD NOT EXCEED THE FOLLOWING: NITROGEN, 100 POUNDS PER ACRE TOTAL OF SOLUBLE NITROGEN; P205 (PHOSPHOROUS), 200 POUNDS PER ACRE; K20 (POTASSIUM),
- II. LIME: USE ONLY GROUND AGRICULTURAL LIMESTONE (UP TO 3 TONS PER ACRE MAY BE APPLIED BY HYDROSEEDING). NORMALLY, NOT MORE THAN 2 TONS ARE APPLIED BY HYDROSEEDING AT ANY ONE TIME. DO NOT USE BURNT OR HYDRATED LIME WHEN
- III. MIX SEED AND FERTILIZER ON SITE AND SEED IMMEDIATELY AND WITHOUT

IV. WHEN HYDROSEEDING DO NOT INCORPORATE SEED INTO THE SOIL.

1. MULCH MATERIALS (IN ORDER OF PREFERENCE)

- A. STRAW CONSISTING OF THOROUGHLY THRESHED WHEAT, RYE, OAT, OR BARLEY AND REASONABLY BRIGHT IN COLOR. STRAW IS TO BE FREE OF NOXIOUS WEED SEEDS AS SPECIFIED IN THE MARYLAND SEED LAW AND NOT MUSTY, MOLDY, CAKED, DECAYED, OR EXCESSIVELY DUSTY. NOTE: USE ONLY STERILE STRAW MULCH IN AREAS WHERE ONE SPECIES OF GRASS IS
- B. WOOD CELLULOSE FIBER MULCH (WCFM) CONSISTING OF SPECIALLY PREPARED WOOD CELLULOSE PROCESSED INTO A UNIFORM FIBROUS PHYSICAL STATE.
- I. WCFM IS TO BE DYED GREEN OR CONTAIN A GREEN DYE IN THE PACKAGE THAT WILL PROVIDE AN APPROPRIATE COLOR TO FACILITATE VISUAL INSPECTION OF THE UNIFORMLY II. WCFM, INCLUDING DYE, MUST CONTAIN NO GERMINATION OR GROWTH INHIBITING
- III. WCFM MATERIALS ARE TO BE MANUFACTURED AND PROCESSED IN SUCH A MANNER THAT THE WOOD CELLULOSE FIBER MULCH WILL REMAIN IN UNIFORM SUSPENSION IN WATER UNDER AGITATION AND WILL BLEND WITH SEED, FERTILIZER AND OTHER ADDITIVES TO FORM A HOMOGENEOUS SLURRY. THE MULCH MATERIAL MUST FORM A BLOTTER-LIKE GROUND COVER, ON APPLICATION, HAVING MOISTURE ABSORPTION AND PERCOLATION
- PROPERTIES AND MUST COVER AND HOLD GRASS SEED IN CONTACT WITH THE SOIL WITHOUT INHIBITING THE GROWTH OF THE GRASS SEEDLINGS. IV. WCFM MATERIAL MUST NOT CONTAIN ELEMENTS OR COMPOUNDS AT CONCENTRATION LEVELS THAT WILL BE PHYTO-TOXIC.
- V. WCFM MUST CONFORM TO THE FOLLOWING PHYSICAL REQUIREMENTS: FIBER LENGTH OF APPROXIMATELY 10 MILLIMETERS, DIAMETER APPROXIMATELY 1 MILLIMETER, PH RANGE OF 4.0 TO 8.5, ASH CONTENT OF 1.6 PERCENT MAXIMUM AND WATER HOLDING CAPACITY OF 90 PERCENT MINIMUM.

2. APPLICATION

- A. APPLY MULCH TO ALL SEEDED AREAS IMMEDIATELY AFTER SEEDING.
- B. WHEN STRAW MULCH IS USED, SPREAD IT OVER ALL SEEDED AREAS AT THE RATE OF 2 TONS PER ACRE TO A UNIFORM LOOSE DEPTH OF 1 TO 2 INCHES. APPLY MULCH TO ACHIEVE A UNIFORM DISTRIBUTION AND DEPTH SO THAT THE SOIL SURFACE IS NOT EXPOSED. WHEN USING A MULCH ANCHORING TOOL, INCREASE THE APPLICATION RATE TO 2.5 TONS PER ACRE.
- C. WOOD CELLULOSE FIBER USED AS MULCH MUST BE APPLIED AT A NET DRY WEIGHT OF 1500 POUNDS PER ACRE. MIX THE WOOD CELLULOSE FIBER WITH WATER TO ATTAIN A MIXTURE WITH A MAXIMUM OF 50 POUNDS OF WOOD CELLULOSE FIBER PER 100 GALLONS OF WATER.
- A. PERFORM MULCH ANCHORING IMMEDIATELY FOLLOWING APPLICATION OF MULCH TO MINIMIZE LOSS BY WIND OR WATER. THIS MAY BE DONE BY ONE OF THE FOLLOWING METHODS (LISTED
- BY PREFERENCE), DEPENDING UPON THE SIZE OF THE AREA AND EROSION HAZARD: I. A MULCH ANCHORING TOOL IS A TRACTOR DRAWN IMPLEMENT DESIGNED TO PUNCH AND ANCHOR MULCH INTO THE SOIL SURFACE A MINIMUM OF 2 INCHES. THIS PRACTICE IS MOST EFFECTIVE ON LARGE AREAS, BUT IS LIMITED TO FLATTER SLOPES WHERE
- FOLLOW THE CONTOUR. II. WOOD CELLULOSE FIBER MAY BE USED FOR ANCHORING STRAW. APPLY THE FIBER BINDER AT A NET DRY WEIGHT OF 750 POUNDS PER ACRE. MIX THE WOOD CELLULOSE FIBER WITH WATER AT A MAXIMUM OF 50 POUNDS OF WOOD CELLULOSE FIBER PER 100

EQUIPMENT CAN OPERATE SAFELY. IF USED ON SLOPING LAND, THIS PRACTICE SHOULD

- III. SYNTHETIC BINDERS SUCH AS ACRYLIC DLR (AGRO-TACK), DCA-70, PETROSET, TERRA TAX II, TERRA TACK AR OR OTHER APPROVED EQUAL MAY BE USED. FOLLOW APPLICATION RATES AS SPECIFIED BY THE MANUFACTURER. APPLICATION OF LIQUID BINDERS NEEDS TO BE HEAVIER AT THE EDGES WHERE WIND CATCHES MULCH, SUCH AS IN VALLEYS AND ON CRESTS OF BANKS. USE OF ASPHALT BINDERS IS STRICTLY PROHIBITED.
- IV. LIGHTWEIGHT PLASTIC NETTING MAY BE STAPLED OVER THE MULCH ACCORDING TO MANUFACTURER RECOMMENDATIONS. NETTING IS USUALLY AVAILABLE IN ROLLS 4 TO 15 FEET WIDE AND 300 TO 3,000 FEET LONG.

PERMANENT STABILIZATION

A. SEED MIXTURES

- A. SELECT ONE OR MORE OF THE SPECIES OR MIXTURES LISTED IN TABLE B.3 FOR THE APPROPRIATE PLANT HARDINESS ZONE (FROM FIGURE B.3) AND BASED ON THE SITE CONDITION OR PURPOSE FOUND ON TABLE B.2. ENTER SELECTED MIXTURE(S), APPLICATION RATES, AND SEEDING DATES IN THE PERMANENT SEEDING SUMMARY. THE SUMMARY IS TO BE PLACED ON THE PLAN.
- B. ADDITIONAL PLANTING SPECIFICATIONS FOR EXCEPTIONAL SITES SUCH AS SHORELINES, STREAM BANKS, OR DUNES OR FOR SPECIAL PURPOSES SUCH AS WILDLIFE OR AESTHETIC TREATMENT MAY BE FOUND IN USDA-NRCS TECHNICAL FIELD OFFICE GUIDE, SECTION 342 - CRITICAL AREA PLANTING.
- C. FOR SITES HAVING DISTURBED AREA OVER 5 ACRES, USE AND SHOW THE RATES RECOMMENDED BY THE SOIL TESTING AGENCY.
- D. FOR AREAS RECEIVING LOW MAINTENANCE, APPLY UREA FORM FERTILIZER (46-0-0) AT 3 1/2 POUNDS PER 1000 SQUARE FEET (150 POUNDS PER ACRE) AT THE TIME OF SEEDING IN ADDITION TO THE SOIL AMENDMENTS SHOWN IN THE PERMANENT SEEDING SUMMARY
- . AREAS WHERE TURFGRASS MAY BE DESIRED INCLUDE LAWNS, PARKS, PLAYGROUNDS, AND COMMERCIAL SITES WHICH WILL RECEIVE A MEDIUM TO HIGH LEVEL OF MAINTENANCE. B. SELECT ONE OR MORE OF THE SPECIES OR MIXTURES LISTED BELOW BASED ON THE SITE
- CONDITIONS OR PURPOSE. ENTER SELECTED MIXTURE(S), APPLICATION RATES, AND SEEDING DATES IN THE PERMANENT SEEDING SUMMARY. THE SUMMARY IS TO BE PLACED ON THE PLAN. . KENTUCKY BLUEGRASS: FULL SUN MIXTURE: FOR USE IN AREAS THAT RECEIVE INTENSIVE MANAGEMENT. IRRIGATION REQUIRED IN THE AREAS OF CENTRAL MARYLAND AND EASTERN SHORE. RECOMMENDED CERTIFIED KENTUCKY BLUEGRASS CULTIVARS SEEDING RATE: 1.5 TO 2.0 POUNDS PER 1000 SQUARE FEET. CHOOSE A MINIMUM OF THREE KENTUCKY BLUEGRASS
- CULTIVARS WITH EACH RANGING FROM 10 TO 35 PERCENT OF THE TOTAL MIXTURE BY WEIGHT II. KENTUCKY BLUEGRASS/PERENNIAL RYE: FULL SUN MIXTURE: FOR USE IN FULL SUN AREAS WHERE RAPID ESTABLISHMENT IS NECESSARY AND WHEN TURF WILL RECEIVE MEDIUM TO INTENSIVE MANAGEMENT. CERTIFIED PERENNIAL RYEGRASS CULTIVARS/CERTIFIED KENTUCKY BLUEGRASS SEEDING RATE: 2 POUNDS MIXTURE PER 1000 SQUARE FEET. CHOOSE A MINIMUM OF THREE KENTUCKY BLUEGRASS CULTIVARS WITH EACH RANGING FROM 10 TO 35 PERCENT OF THE
- TOTAL MIXTURE BY WEIGHT. III. TALL FESCUE/KENTUCKY BLUEGRASS: FULL SUN MIXTURE: FOR USE IN DROUGHT PRONE AREAS AND/OR FOR AREAS RECEIVING LOW TO MEDIUM MANAGEMENT IN FULL SUN TO MEDIUM SHADE. RECOMMENDED MIXTURE INCLUDES; CERTIFIED TALL FESCUE CULTIVARS 95 TO 100 PERCENT, CERTIFIED KENTUCKY BLUEGRASS CULTIVARS 0 TO 5 PERCENT. SEEDING RATE: 5 TO 8
- POUNDS PER 1000 SQUARE FEET. ONE OR MORE CULTIVARS MAY BE BLENDED. IV. KENTUCKY BLUEGRASS/FINE FESCUE: SHADE MIXTURE: FOR USE IN AREAS WITH SHADE IN BLUEGRASS LAWNS. FOR ESTABLISHMENT IN HIGH QUALITY, INTENSIVELY MANAGED TURF AREA. MIXTURE INCLUDES; CERTIFIED KENTUCKY BLUEGRASS CULTIVARS 30 TO 40 PERCENT AND CERTIFIED FINE FESCUE AND 60 TO 70 PERCENT. SEEDING RATE: 11/2 TO 3 POUNDS PER 1000
- NOTES: SELECT TURFGRASS VARIETIES FROM THOSE LISTED IN THE MOST CURRENT UNIVERSITY OF MARYLAND PUBLICATION, AGRONOMY MEMO #77, "TURFGRASS CULTIVAR RECOMMENDATIONS
- CHOOSE CERTIFIED MATERIAL. CERTIFIED MATERIAL IS THE BEST GUARANTEE OF CULTIVAR PURITY. THE CERTIFICATION PROGRAM OF THE MARYLAND DEPARTMENT OF AGRICULTURE, TURF AND SEED SECTION, PROVIDES A RELIABLE MEANS OF CONSUMER PROTECTION AND ASSURES A PURE
- C. IDEAL TIMES OF SEEDING FOR TURF GRASS MIXTURES ARE: MARCH 1 TO MAY 15, AUGUST 15 TO
- D. TILL AREAS TO RECEIVE SEED BY DISKING OR OTHER APPROVED METHODS TO A DEPTH OF 2 TO 4 INCHES, LEVEL AND RAKE THE AREAS TO PREPARE A PROPER SEEDBED. REMOVE STONES AND DEBRIS OVER 11/2 INCHES IN DIAMETER. THE RESULTING SEEDBED MUST BE IN SUCH CONDITION THAT FUTURE MOWING OF GRASSES WILL POSE NO DIFFICULTY.
- E. IF SOIL MOISTURE IS DEFICIENT, SUPPLY NEW SEEDINGS WITH ADEQUATE WATER FOR PLANT GROWTH (1/2 TO 1 INCH EVERY 3 TO 4 DAYS DEPENDING ON SOIL TEXTURE) UNTIL THEY ARE FIRMLY ESTABLISHED. THIS IS ESPECIALLY TRUE WHEN SEEDINGS ARE MADE LATE IN THE PLANTING SEASON, IN ABNORMALLY DRY OR HOT SEASONS, OR ON ADVERSE SITES.
- B. SOD: TO PROVIDE QUICK COVER ON DISTURBED AREAS (2:1 GRADE OR FLATTER). 1. GENERAL SPECIFICATIONS
 - A. CLASS OF TURFGRASS SOD MUST BE MARYLAND STATE CERTIFIED. SOD LABELS MUST BE MADE
 - B. SOD MUST BE MACHINE CUT AT A UNIFORM SOIL THICKNESS OF 3/4 INCH, PLUS OR MINUS 1/4 INCH, BROKEN PADS AND TORN OR UNEVEN ENDS WILL NOT BE ACCEPTABLE.
 - C. STANDARD SIZE SECTIONS OF SOD MUST BE STRONG ENOUGH TO SUPPORT THEIR OWN WEIGHT AND RETAIN THEIR SIZE AND SHAPE WHEN SUSPENDED VERTICALLY WITH A FIRM GRASP ON THE UPPER 10
- D. SOD MUST NOT BE HARVESTED OR TRANSPLANTED WHEN MOISTURE CONTENT (EXCESSIVELY DRY OR WET) MAY ADVERSELY AFFECT ITS SURVIVAL. E. SOD MUST BE HARVESTED, DELIVERED, AND INSTALLED WITHIN A PERIOD OF 36 HOURS. SOD NOT TRANSPLANTED WITHIN THIS PERIOD MUST BE APPROVED BY AN AGRONOMIST OR SOIL SCIENTIST

2. SOD INSTALLATION A. DURING PERIODS OF EXCESSIVELY HIGH TEMPERATURE OR IN AREAS HAVING DRY SUBSOIL, LIGHTLY IRRIGATE THE SUBSOIL IMMEDIATELY PRIOR TO LAYING THE SOD.

B. LAY THE FIRST ROW OF SOD IN A STRAIGHT LINE WITH SUBSEQUENT ROWS PLACED PARALLEL TO

UNIFORM GROWTH AND STRENGTH. ENSURE THAT SOD IS NOT STRETCHED OR OVERLAPPED AND THAT ALL JOINTS ARE BUTTED TIGHT IN ORDER TO PREVENT VOIDS WHICH WOULD CAUSE AIR DRYING OF C. WHEREVER POSSIBLE, LAY SOD WITH THE LONG EDGES PARALLEL TO THE CONTOUR AND WITH STAGGERING JOINTS. ROLL AND TAMP, PEG OR OTHERWISE SECURE THE SOD TO PREVENT SLIPPAGE

IT AND TIGHTLY WEDGED AGAINST EACH OTHER. STAGGER LATERAL JOINTS TO PROMOTE MORE

- ON SLOPES. ENSURE SOLID CONTACT EXISTS BETWEEN SOD ROOTS AND THE UNDERLYING SOIL SURFACE. D. WATER THE SOD IMMEDIATELY FOLLOWING ROLLING AND TAMPING UNTIL THE UNDERSIDE OF THE NEW SOD PAD AND SOIL SURFACE BELOW THE SOD ARE THOROUGHLY WET. COMPLETE THE
- OPERATIONS OF LAYING, TAMPING AND IRRIGATING FOR ANY PIECE OF SOD WITHIN EIGHT HOURS. 3. SOD MAINTENANCE
- A. IN THE ABSENCE OF ADEQUATE RAINFALL, WATER DAILY DURING THE FIRST WEEK OR AS OFTEN AND SUFFICIENTLY AS NECESSARY TO MAINTAIN MOIST SOIL TO A DEPTH OF 4 INCHES. WATER SOD DURING THE HEAT OF THE DAY TO PREVENT WILTING. B. AFTER THE FIRST WEEK, SOD WATERING IS REQUIRED AS NECESSARY TO MAINTAIN ADEQUATE
- C. DO NOT MOW UNTIL THE SOD IS FIRMLY ROOTED. NO MORE THAN $1/3\,$ OF THE GRASS LEAF MUST BE REMOVED BY THE INITIAL CUTTING OR SUBSEQUENT CUTTINGS. MAINTAIN A GRASS HEIGHT OF AT LEAST 3 INCHES UNLESS OTHERWISE SPECIFIED.

DATUM: NAD 83/91 Horizontal

NAVD 88 Vertical

- INCREMENTAL STABILIZATION
- A. INCREMENTAL STABILIZATION CUT SLOPES
- I. EXCAVATE AND STABILIZE CUT SLOPES IN INCREMENTS NOT TO EXCEED 15 FEET IN HEIGHT. PREPARE SEEDBED AND APPLY SEED AND MULCH ON ALL CUT SLOPES AS THE
- 2. FOR CONSTRUCTION SEQUENCE REFER TO SHEET C-330.
- NOTE: ONCE EXCAVATION HAS BEGUN THE OPERATION SHOULD BE CONTINUOUS FROM GRUBBING THROUGH THE COMPLETION OF GRADING AND PLACEMENT OF TOPSOIL (IF REQUIRED) AND PERMANENT SEED AND MULCH. ANY INTERRUPTIONS IN THE OPERATION OR COMPLETING THE OPERATION OUT OF THE SEEDING SEASON WILL NECESSITATE THE APPLICATION OF TEMPORARY STABILIZATION.
- B. INCREMENTAL STABILIZATION FILL SLOPES
- 1. CONSTRUCT AND STABILIZE FILL SLOPES IN INCREMENTS NOT TO EXCEED 15 FEET IN HEIGHT. PREPARE SEEDBED AND APPLY SEED AND MULCH ON ALL SLOPES AS THE

AS NECESSARY, TO INTERCEPT SURFACE RUNOFF AND CONVEY IT DOWN THE SLOPE IN

- 2. STABILIZE SLOPES IMMEDIATELY WHEN THE VERTICAL HEIGHT OF A LIFT REACHES 15 FEET, OR WHEN THE GRADING OPERATION CEASES AS PRESCRIBED IN THE PLANS. 3. AT THE END OF EACH DAY, INSTALL TEMPORARY WATER CONVEYANCE PRACTICE(S)
- A NON-EROSIVE MANNER. 4. FOR CONSTRUCTION SEQUENCE REFER TO SHEET C-330.
- NOTE: ONCE THE PLACEMENT OF FILL HAS BEGUN THE OPERATION SHOULD BE CONTINUOUS FROM GRUBBING THROUGH THE COMPLETION OF GRADING AND PLACEMENT OF TOPSOIL (IF REQUIRED) AND PERMANENT SEED AND MULCH. ANY INTERRUPTIONS IN THE OPERATION OR COMPLETING THE OPERATION OUT OF THE SEEDING SEASON WILL NECESSITATE THE APPLICATION OF TEMPORARY STABILIZATION.

TEMPORARY SEEDING TABLE B.1

CEED MIXTURE (HARDINESS ZONE SE.)

	SEED M	IXTURE (HARDII FROM TABLI	FERTILIZER RATE	LIME RATE		
NO.	SPECIES	APPLICATION RATE (lb/ac)	SEEDING DATES	SEEDING DEPTHS	(10–10–10)	
	BARLEY	96	3/1-5/15 8/1-10/15	1"		
	CEREAL RYE	112	3/1-5/15 8/1-11/15	1"	436 lb/ac	2 tons/ac
	WHEAT	120	3/1-5/15 8/1-10/15	1"	(10 lb/1000 sf)	(90 lb/1000 sf)
	FOXTAIL MILLET	30	5/16-7/31	1/2*		

APPLIES TO EXPOSED SOILS WHERE GROUND COVER IS NEEDED FOR A PERIOD OF 6 MONTHS OR LESS. FOR LONGER DURATION OF TIME, PERMANENT STABILIZATION

STANDARD TREE CANOPY NOTES

PRACTICES ARE REQUIRED.

ANY SHADE TREE PLANTED TO COMPLY WITH CHAPTER 55 OF THE COUNTY CODE MUST EACH SHADE TREE MUST MEET THE REQUIREMENTS FOR PLANT MATERIAL IN

- 2. EACH SHADE TREE MUST BE A MINIMUM OF 2"CALIPER;
- INSTALLATION OF EACH SHADE TREE MUST MEET ALL REQUIREMENTS OF ANSI
- a. TREE GUARDS TO PROTECT TREES FROM DEER RUBBING, MOWERS, WEED EATERS, OTHER EQUIPMENT AND LARGE RODENTS MUST BE INSTALLED
- MULCH MUST BE APPLIED: c. SUFFICIENT WATER MUST BE APPLIED TO AID IN PROPER PLANTING.
- AS THE GROUND IS NOT FROZEN, SATURATED, OR COVERED WITH SNOW SUCH THAT A SHADE TREES MUST NOT BE INSTALLED BETWEEN MAY 16TH AND OCTOBER 14TH OF

5. SHADE TREES MUST BE INSTALLED BETWEEN OCTOBER 15TH AND MAY 15TH AS LONG

- EACH YEAR. IF INSTALLATION CANNOT OCCUR BETWEEN OCTOBER 15TH AND MAY 15TH FOR ANY REASON, OR IF PROPOSED TREES ARE NOT PLANTED FOR ANY OTHER REASON, THE PERMITTEE MUST PAY THE REQUIRED FEE IN LIEU. 7. IF SHADE TREES ARE INSTALLED PRIOR TO FINAL STABILIZATION OF THE LAND DISTURBING ACTIVITY THEN NO ADDITIONAL DISTURBANCE MUST OCCUR WITHIN FIVE FEET OF THE STEM OF THE TREE. PROTECTIVE FENCING MUST BE INSTALLED AT THE EDGE OF THIS AREA AT THE SAME TIME THE TREE IS INSTALLED AND MUST REMAIN IN PLACE UNTIL FINAL
- THE LOCATION OF GROWING ZONES AND PLANTING AREAS MUST BE CLEARLY MARKED

IN THE FIELD PRIOR TO INSTALLATION OF ANY SHADE TREE.

9. A COPY OF THE APPROVED SEDIMENT CONTROL PLAN SHOWING ALL APPROVED GROWING ZONES AND PLANTING AREAS MUST BE AVAILABLE ON THE SITE AT ALL TIMES. 10. AT LEAST ONE INSPECTION MUST OCCUR AFTER ALL CONSTRUCTION ACTIVITIES ARE COMPLETED TO DETERMINE THE LEVEL OF COMPLIANCE WITH SHADE TREE PLANTING

ESC/SWM SHEET 8 OF 11

REQUIREMENTS.

TOWN OF GARRETT PARK PEDESTRIAN FACILITY DESIGN SERVICES

SAFE ROUTES TO SCHOOL (SRTS)


CROSS REFERENCE		REVISIONS	EROSION & SEDIMENT CONTROL NOTES			TROL NOTES	
	ITEM	SHEET NOs.		SCALE_N.T.S/	ADVERTISED DATE OC	T. 2017	CONTRACT NO. TBD
	COVER GENERAL NOTES AND TYPICAL DETAILS TYPICAL SECTIONS GEOMETRIC LAYOUT SIDEWALK PLANS ADA ENLARGEMENTS EROSION & SEDIMENT CONTROL PLANS EROSION & SEDIMENT CONTROL DETAILS EROSION & SEDIMENT CONTROL NOTES OUTFALL STABILIZATION PLAN AND DETAILS TREE PROTECTION PLANS TREE PROTECTION DETAILS	$ \begin{array}{cccccccccccccccccccccccccccccccccccc$		DESIGNED BY DRAWN BY CHECKED BY F.A.P. NO DRAWING NO.	ME ME JA	COUNTY LOGMILE HORIZON VERTICA	MONTGOMERY ITAL SCALE L SCALE SHEET NO. 20 OF 29
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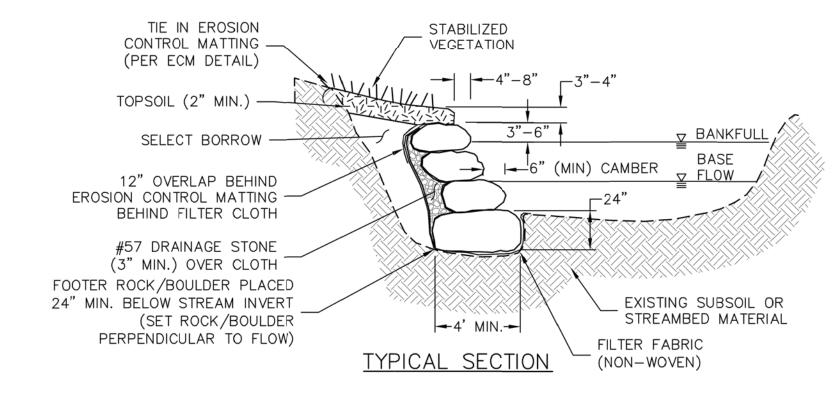
CLARK | AZAR & ASSOCIATES 20410 Century Blvd, Suite 230 Germantown, MD. 20874 T(301) 528-2010 www.clarkazar.com

A Woman Owned Small Business

F MARL PROFESSIONAL CERTIFICATION I CERTIFY THAT THESE DOCUMENTS WERE PREPARED OR APPROVED BY ME, AND THAT I AM A DULY LICENSED PROFESSIONAL ENGINEER UNDER THE LAWS OF THE STATE OF MARYLAND. LICENSE NO. <u>31168</u> EXPIRATION DATE: 1/12/2019





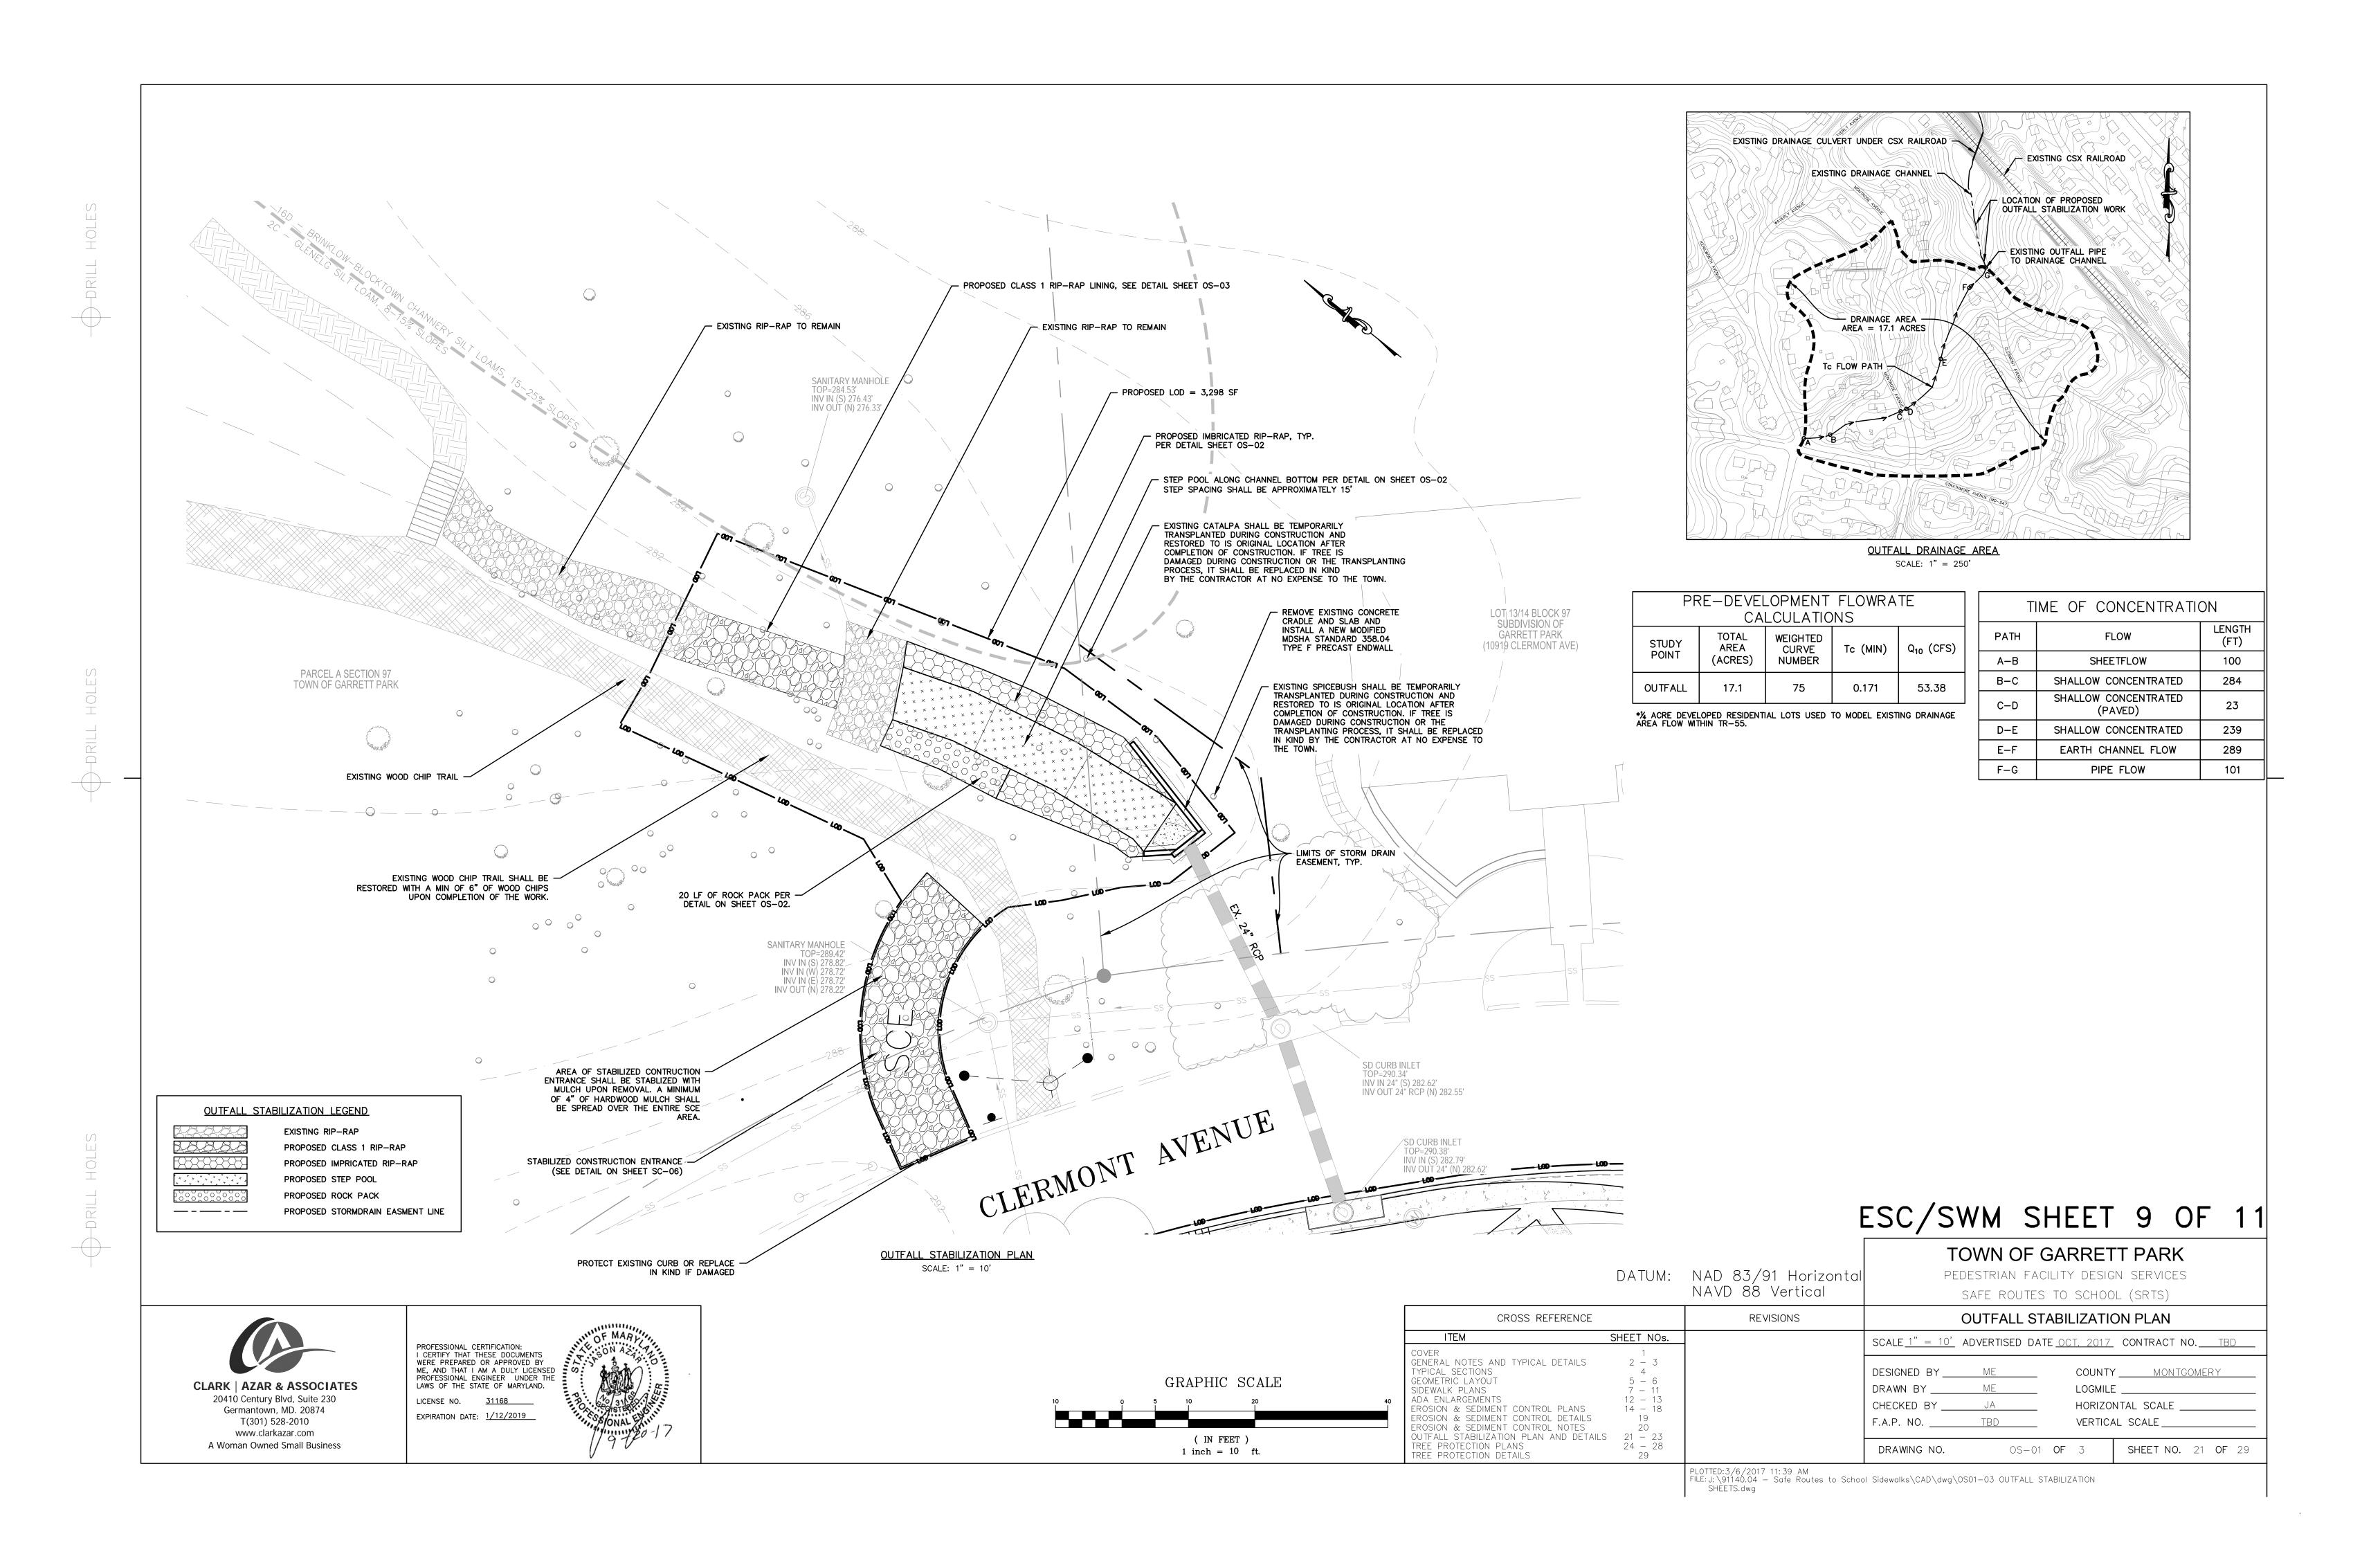

ISOMETRIC VIEW

FILL GAPS BETWEEN STONES

SLOPE ABOVE

(SEE PLANS)

- AS NEEDED TO TRANSITION INTO

PROPOSED TOP OF SLOPE

SEE PLAN FOR DETAILS

ON SEEDING, EROSION CONTROL -PLACEMENT PLANTING, AND SLOPE

BANKFULL

LEADING AND TAILING

ENDS OF WALL TAPERED -15°-30° INTO BANK

BASE FLOW ELEVATION


STREAM CHANNEL INVERT —

MIN. BELOW STREAM INVERT

PERPENDICULAR TO FLOW)

(SET ROCK/BOULDER


FOOTER ROCK/BOULDER PLACED 24"

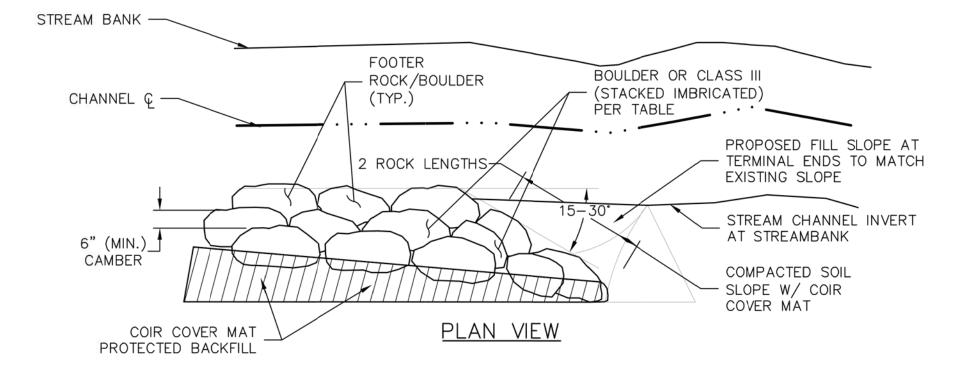



	IMBRICATED RIPRAP WALL (IRR) TABLE									
		OFFSET		BOTTOM ELEV.	TOP ROCKS MIN. DIMENSIONS FOOTER ROCK MIN. DIMENSION				MENSIONS	
STR.#	STA.		TOP ELEV.		LENGTH (L)	HEIGHT (H)	WIDTH (W)	LENGTH (L)	HEIGHT (H)	WIDTH (W)
					12" - 18"	16"-20"	18"-24"	24"-30"	24"-30"	36"-48"


IMBRICATED RIP-RAP DETAIL



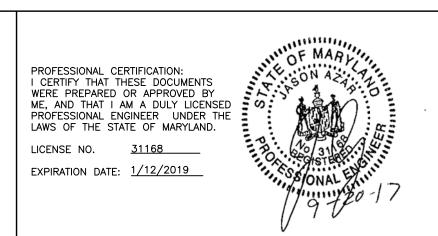

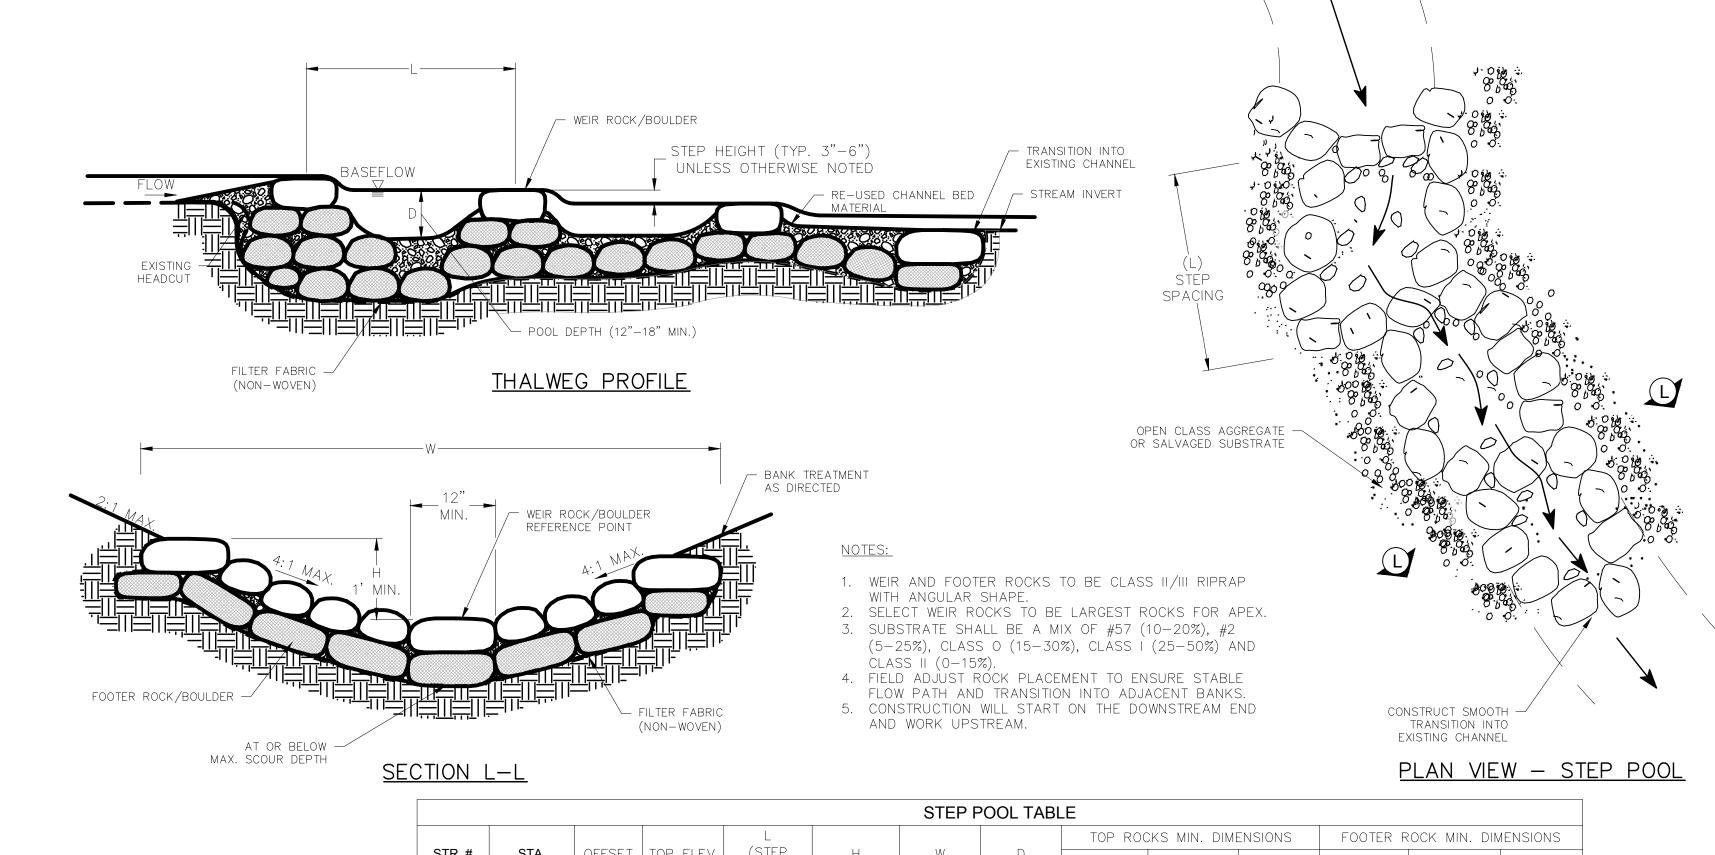

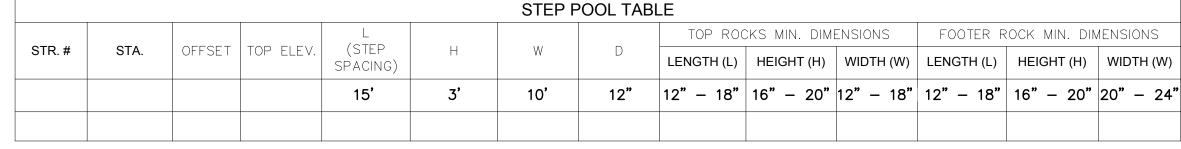

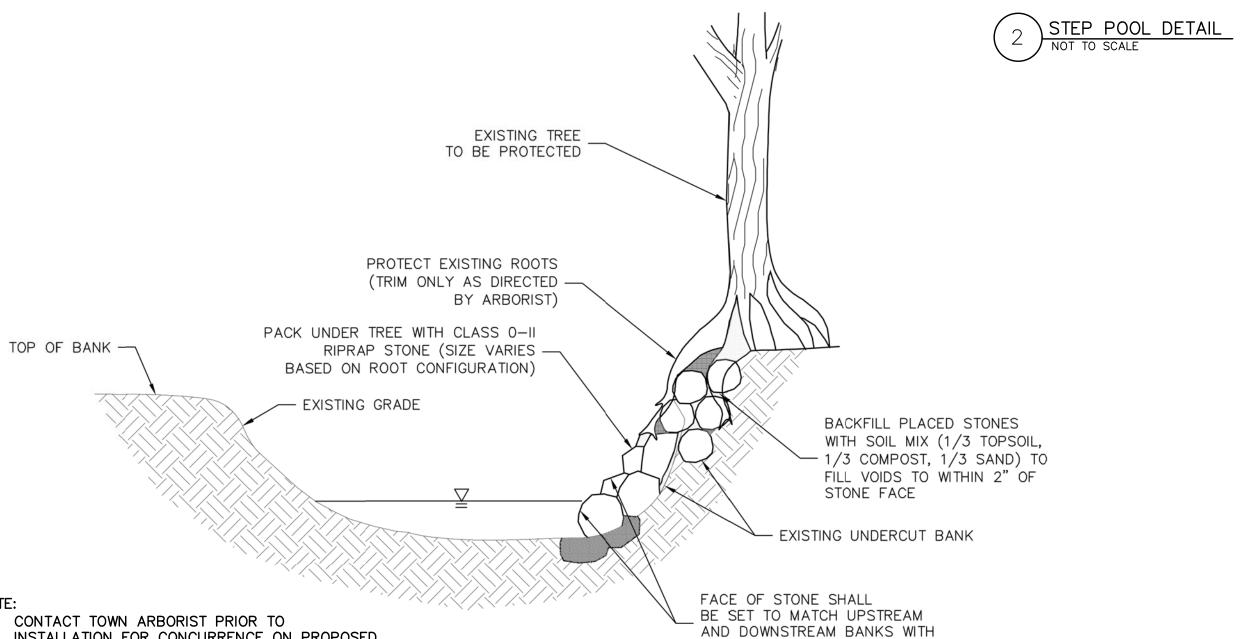

MINIMAL PROTRUSION INTO BANK

ESC/SWM SHEET 10 OF 11

DATUM: NAD 83/91 Horizontal NAVD 88 Vertical

TOWN OF GARRETT PARK PEDESTRIAN FACILITY DESIGN SERVICES SAFE ROUTES TO SCHOOL (SRTS)

CROSS REFERENCE		REVISIONS	OUTFALL STABILIZATION DETAILS
ITEM COVER GENERAL NOTES AND TYPICAL DETAILS TYPICAL SECTIONS GEOMETRIC LAYOUT SIDEWALK PLANS ADA ENLARGEMENTS EROSION & SEDIMENT CONTROL PLANS EROSION & SEDIMENT CONTROL DETAILS EROSION & SEDIMENT CONTROL NOTES OUTFALL STABILIZATION PLAN AND DETAIL TREE PROTECTION PLANS	4 5 - 6 7 - 11 12 - 13 14 - 18 19 20 LS 21 - 23 24 - 28		SCALE N.T.S. ADVERTISED DATE OCT. 2017 CONTRACT NO. TBD DESIGNED BY ME COUNTY MONTGOMERY DRAWN BY ME LOGMILE HORIZONTAL SCALE F.A.P. NO. TBD VERTICAL SCALE DRAWING NO. OS-02 OF 3 SHEET NO. 22 OF 29
TREE PROTECTION DETAILS	29	PLOTTED: 3/6/2017 11: 39 AM	N Sidewalks\CAD\dwa\OSO1-O3 OLITEALL STARILIZATION


ILE: J: \91140.04 — Safe Routes to School Sidewalks\CAD\dwg\OS01—03 OUTFALL STABILIZATION SHEETS.dwg


1) CONTACT TOWN ARBORIST PRIOR TO INSTALLATION FOR CONCURRENCE ON PROPOSED ROOT/TRUNK PROTECTION. THE CONTRACTORS CERTIFIED TREE EXPERT SHALL MAKE RECOMMEDATIONS IN WRITING TO THE TOWN FOR

ROOT/TRUNK PROTECTION. 2) CONTRACTOR SHALL USE EXTREME CAUTION WHEN PLACING ROCKS IN AND AROUND ROOTS.

3) DO NOT USE FILTER FABRIC

ROCK PACK DETAIL

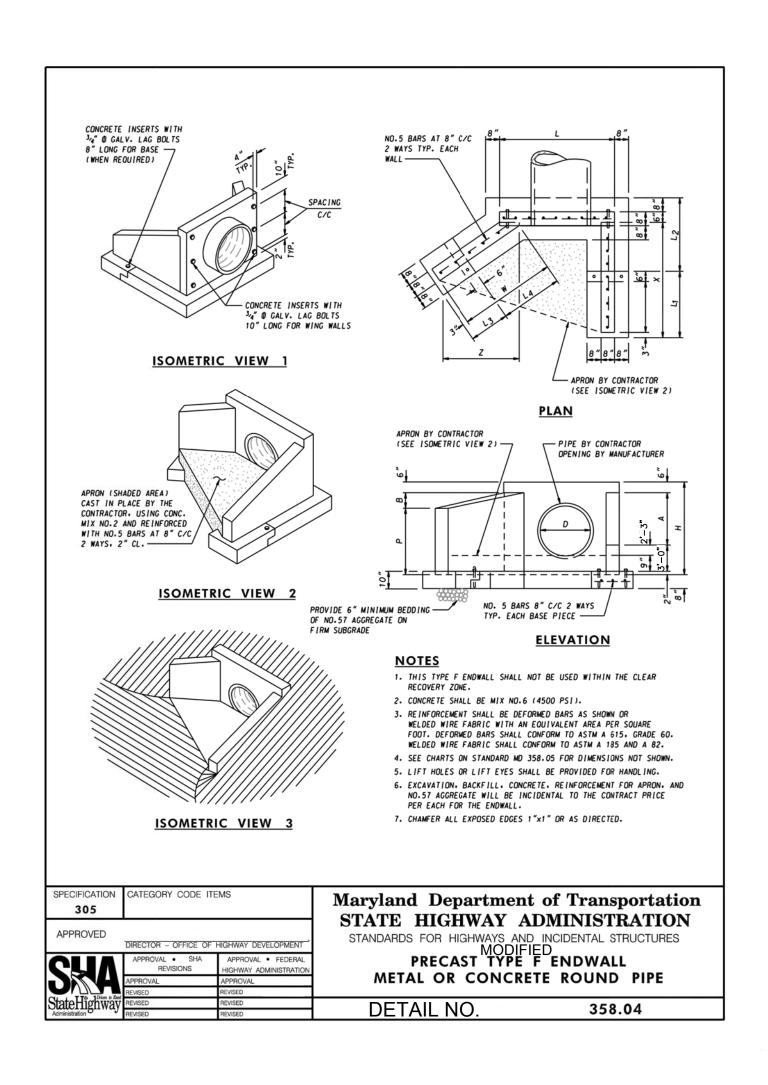

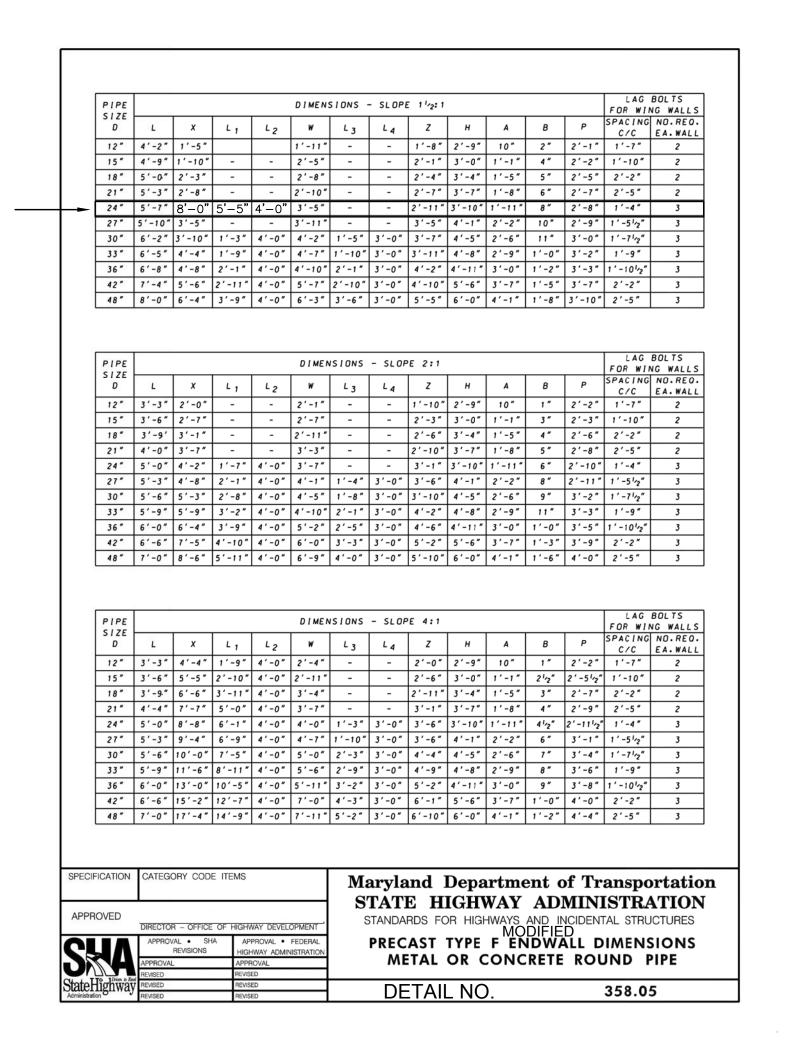



ESC/SWM SHEET 11 OF 11


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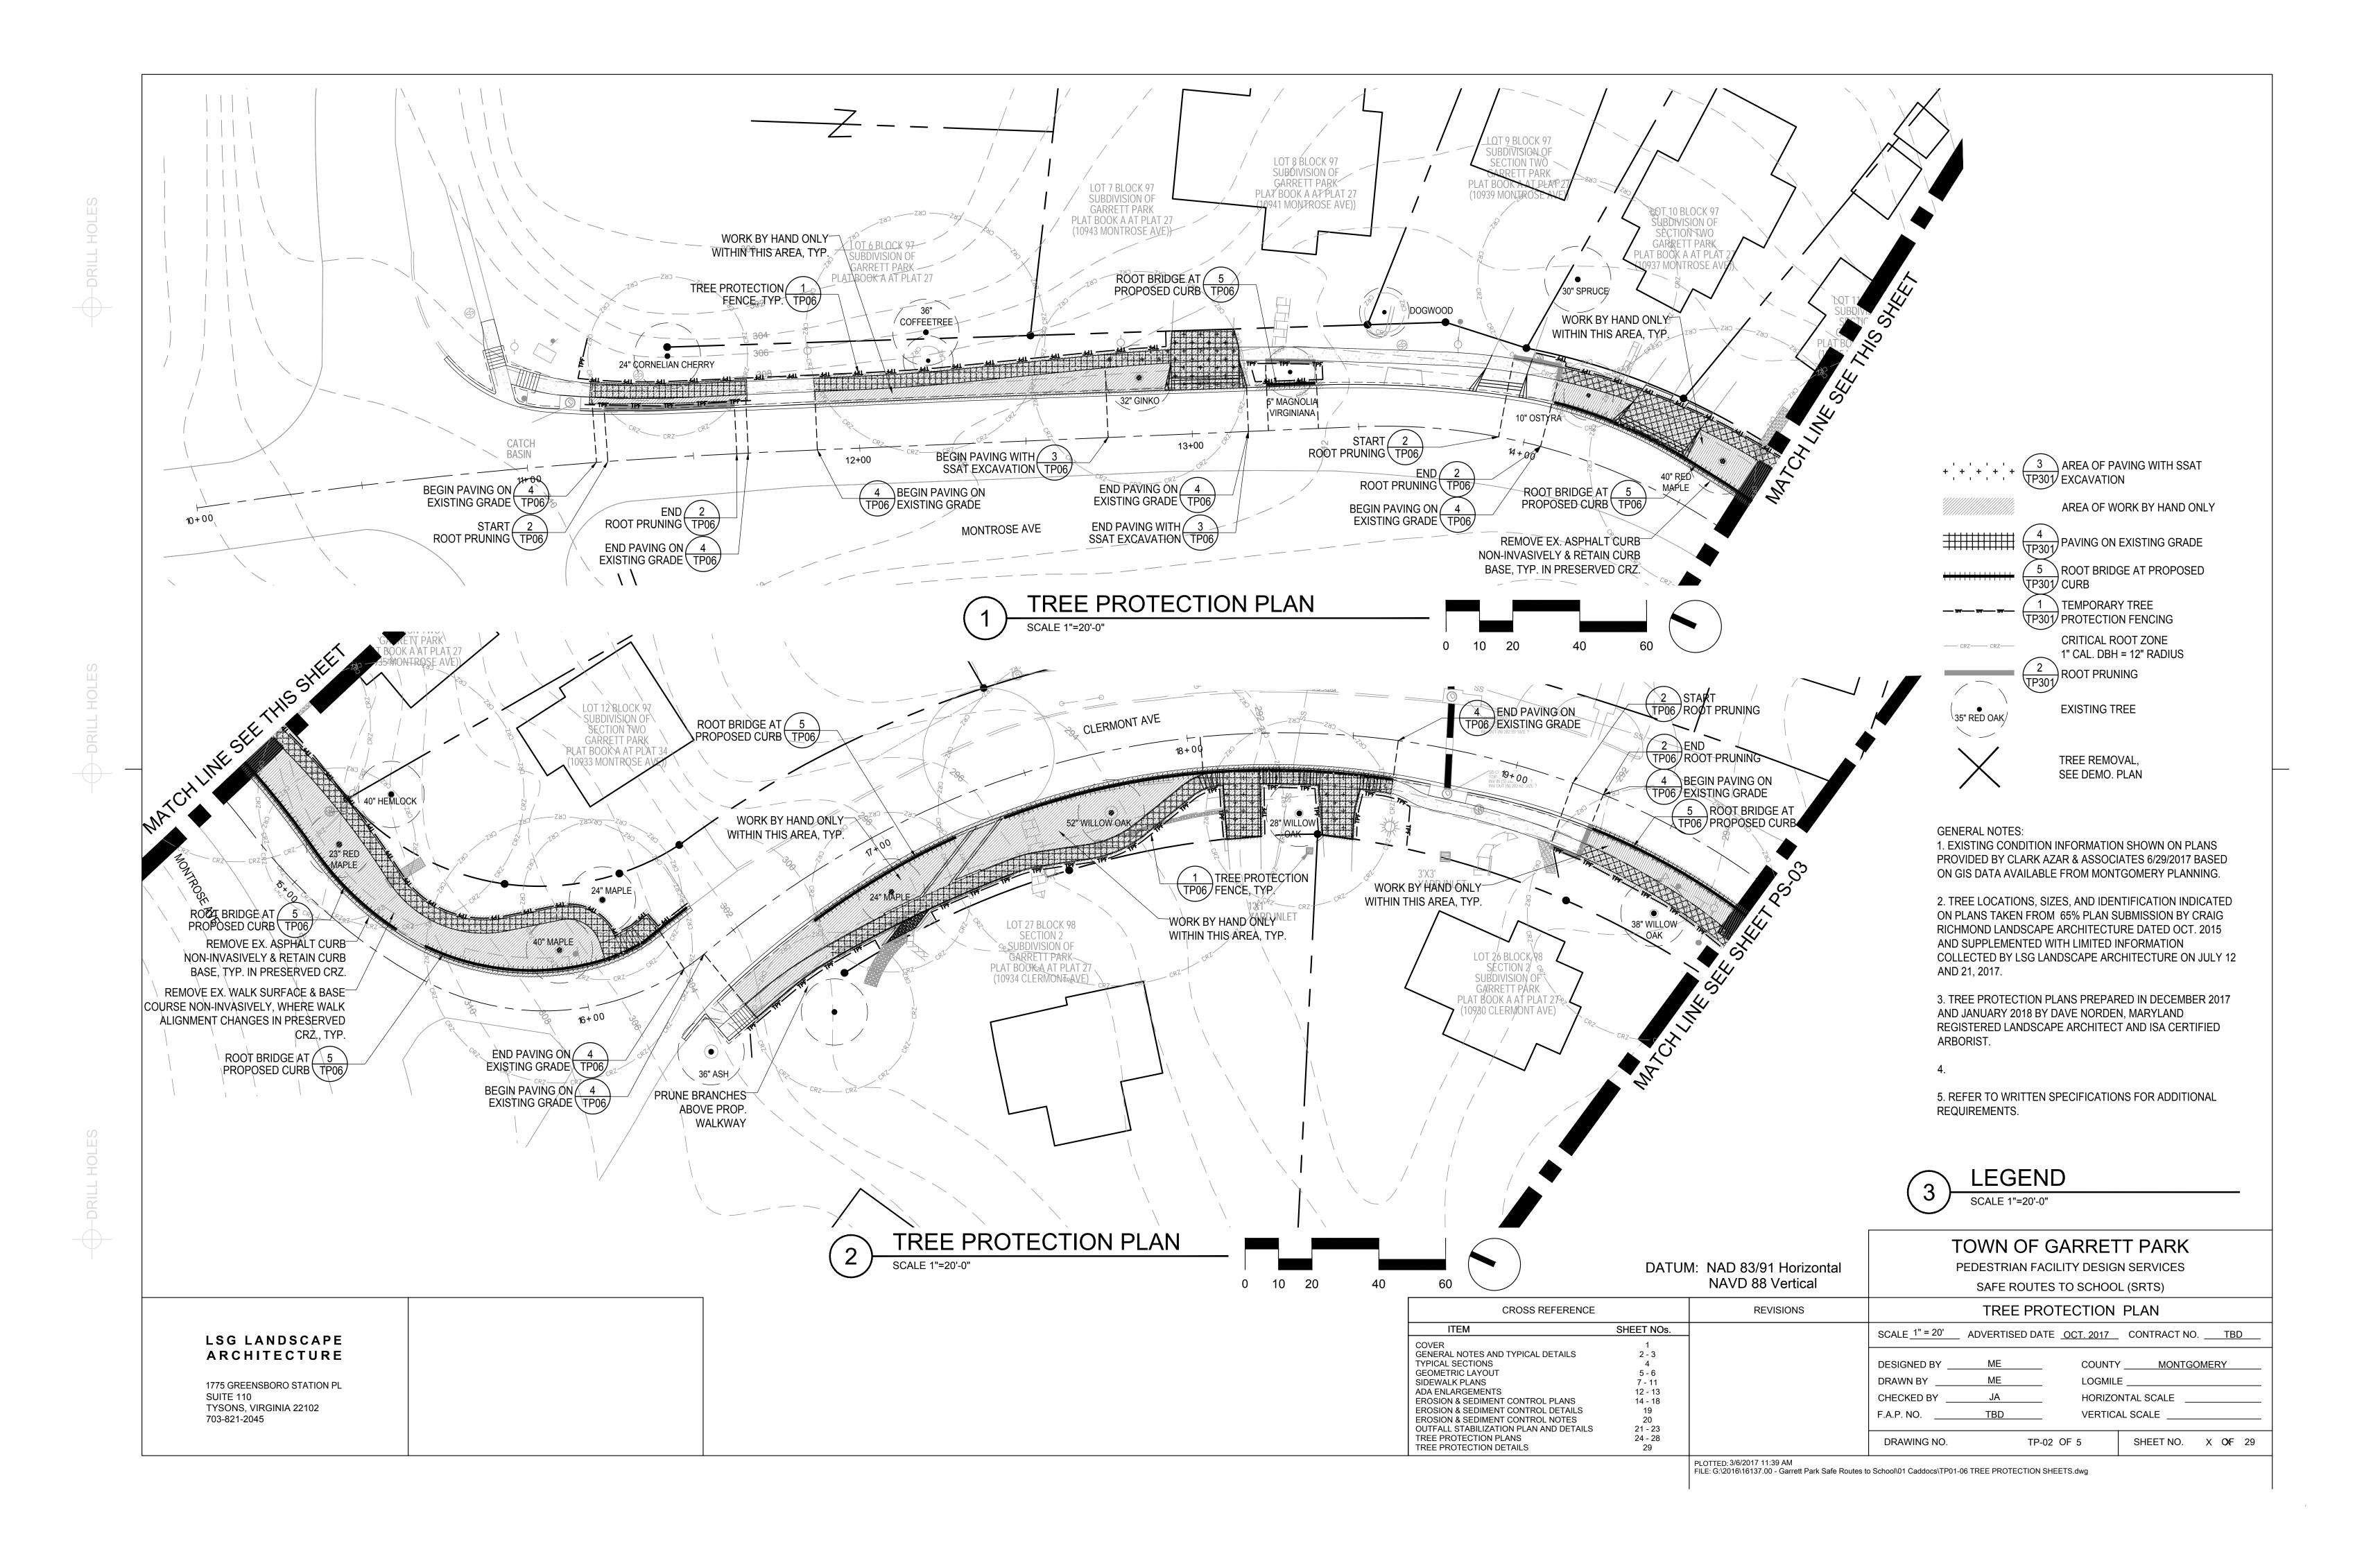
TOWN OF GARRETT PARK PEDESTRIAN FACILITY DESIGN SERVICES


		NAVD 88 Vertical	SAFE ROUTES TO SCHOOL (SRTS)			
CROSS REFERENCE		REVISIONS	OUTFALL STABILIZATION DETAILS			
ITEM COVER	SHEET NOs.		SCALE N.T.S. ADVERTISED D	ATE <u>OCT. 2017</u>	7 CONTRACT NO. TBD	
GENERAL NOTES AND TYPICAL DE TYPICAL SECTIONS GEOMETRIC LAYOUT SIDEWALK PLANS ADA ENLARGEMENTS EROSION & SEDIMENT CONTROL F EROSION & SEDIMENT CONTROL D EROSION & SEDIMENT CONTROL D OUTFALL STABILIZATION PLAN AN TREE PROTECTION PLANS TREE PROTECTION DETAILS	4 5 - 6 7 - 11 12 - 13 LANS 14 - 18 ETAILS 19 OTES 20		DESIGNED BY ME DRAWN BY ME CHECKED BY JA F.A.P. NO. TBD DRAWING NO. OS-C	LOGMIL HORIZO	MONTGOMERY LE ONTAL SCALE CAL SCALE SHEET NO. 23 OF 29	
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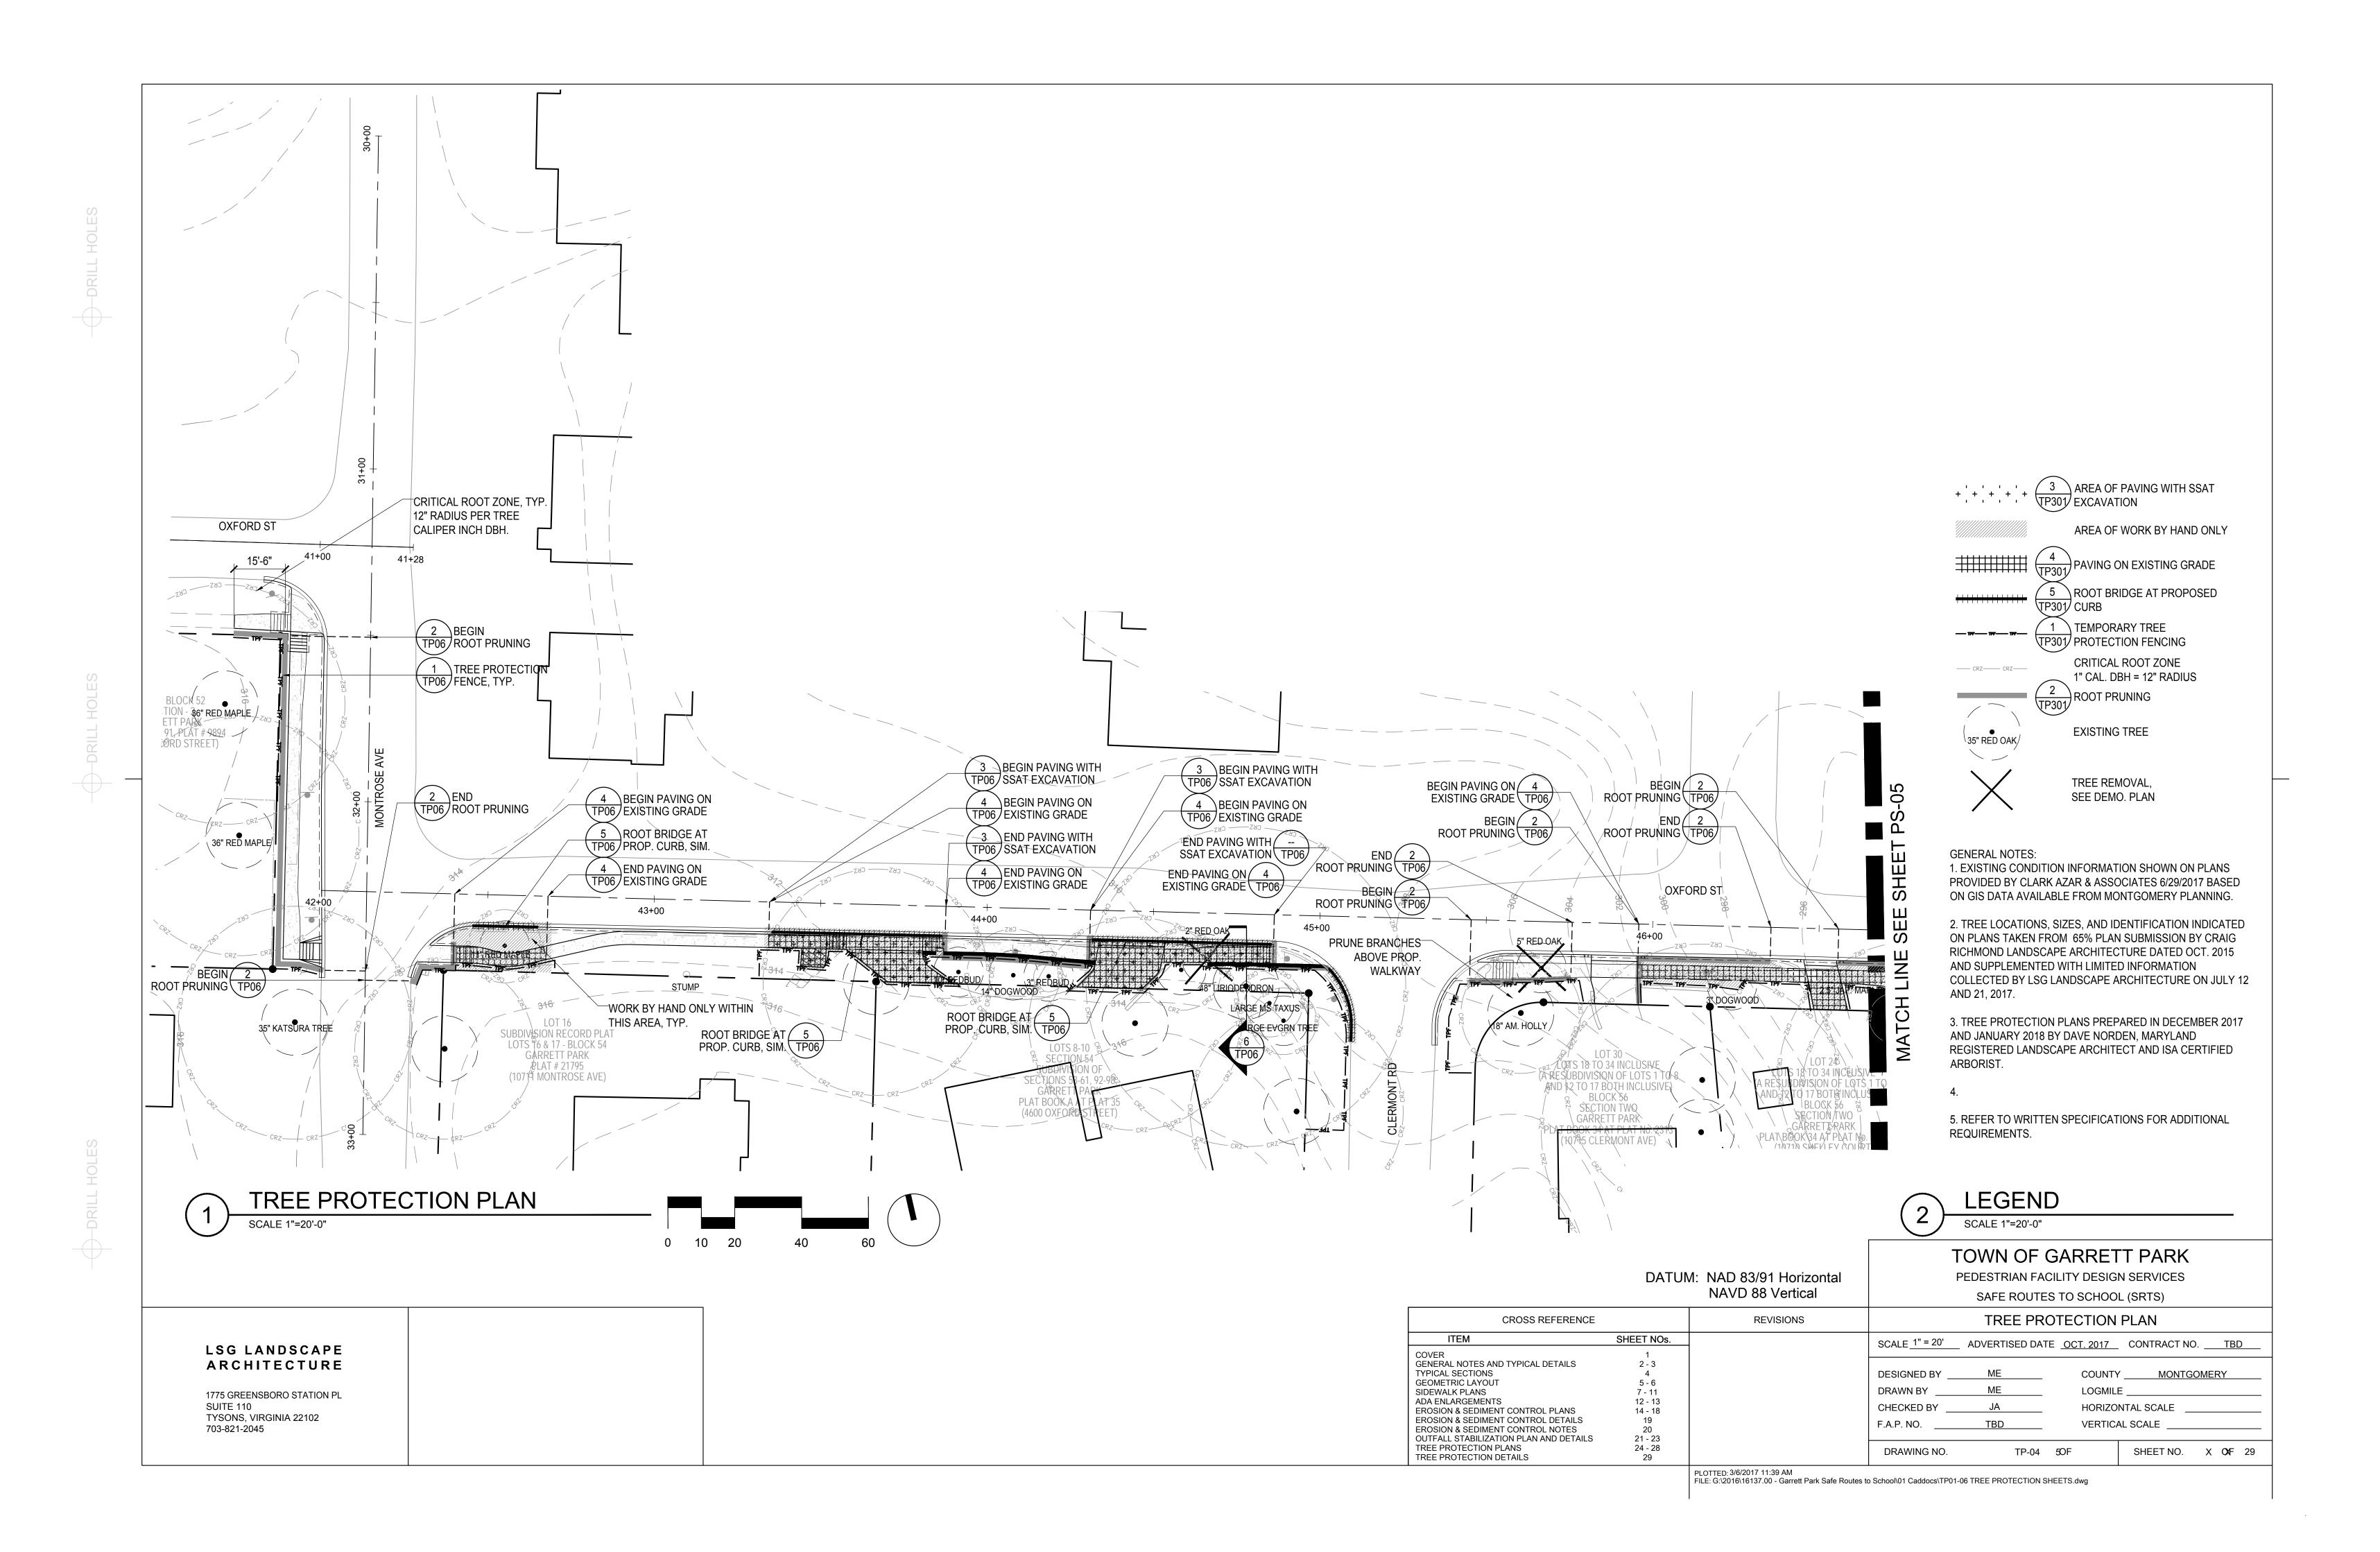





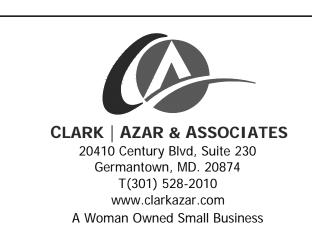

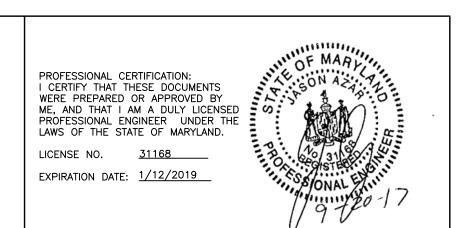

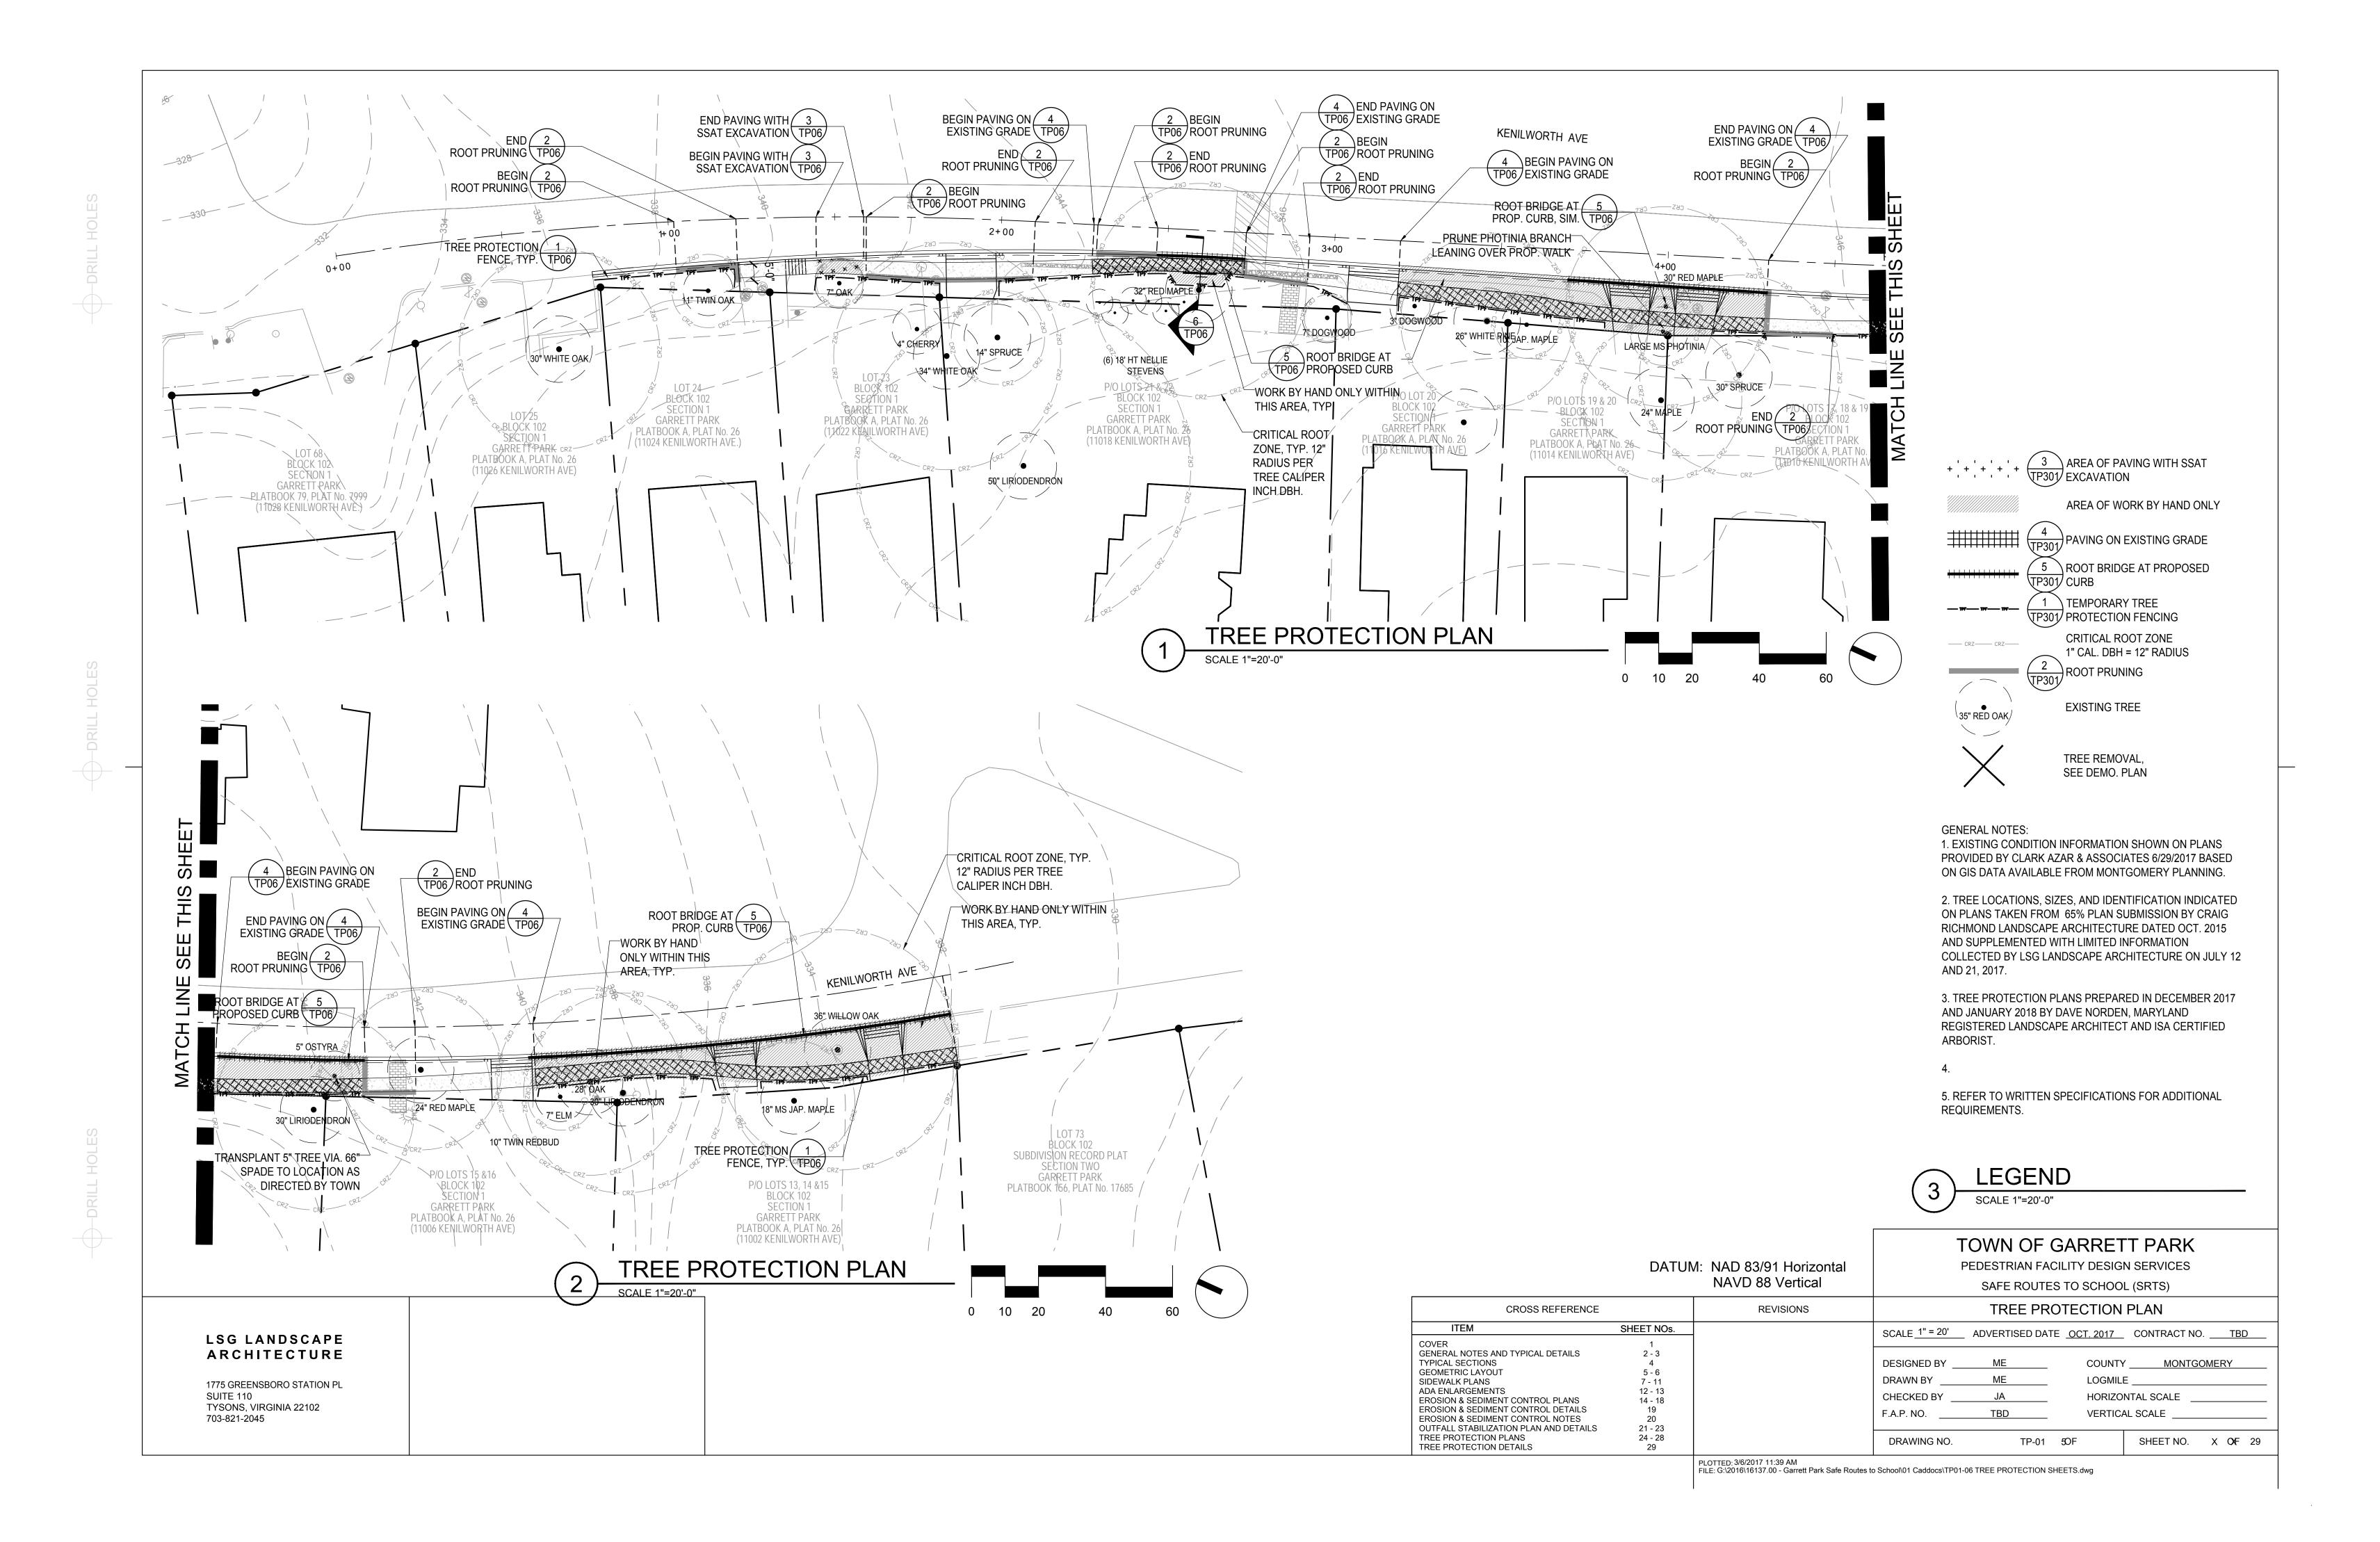

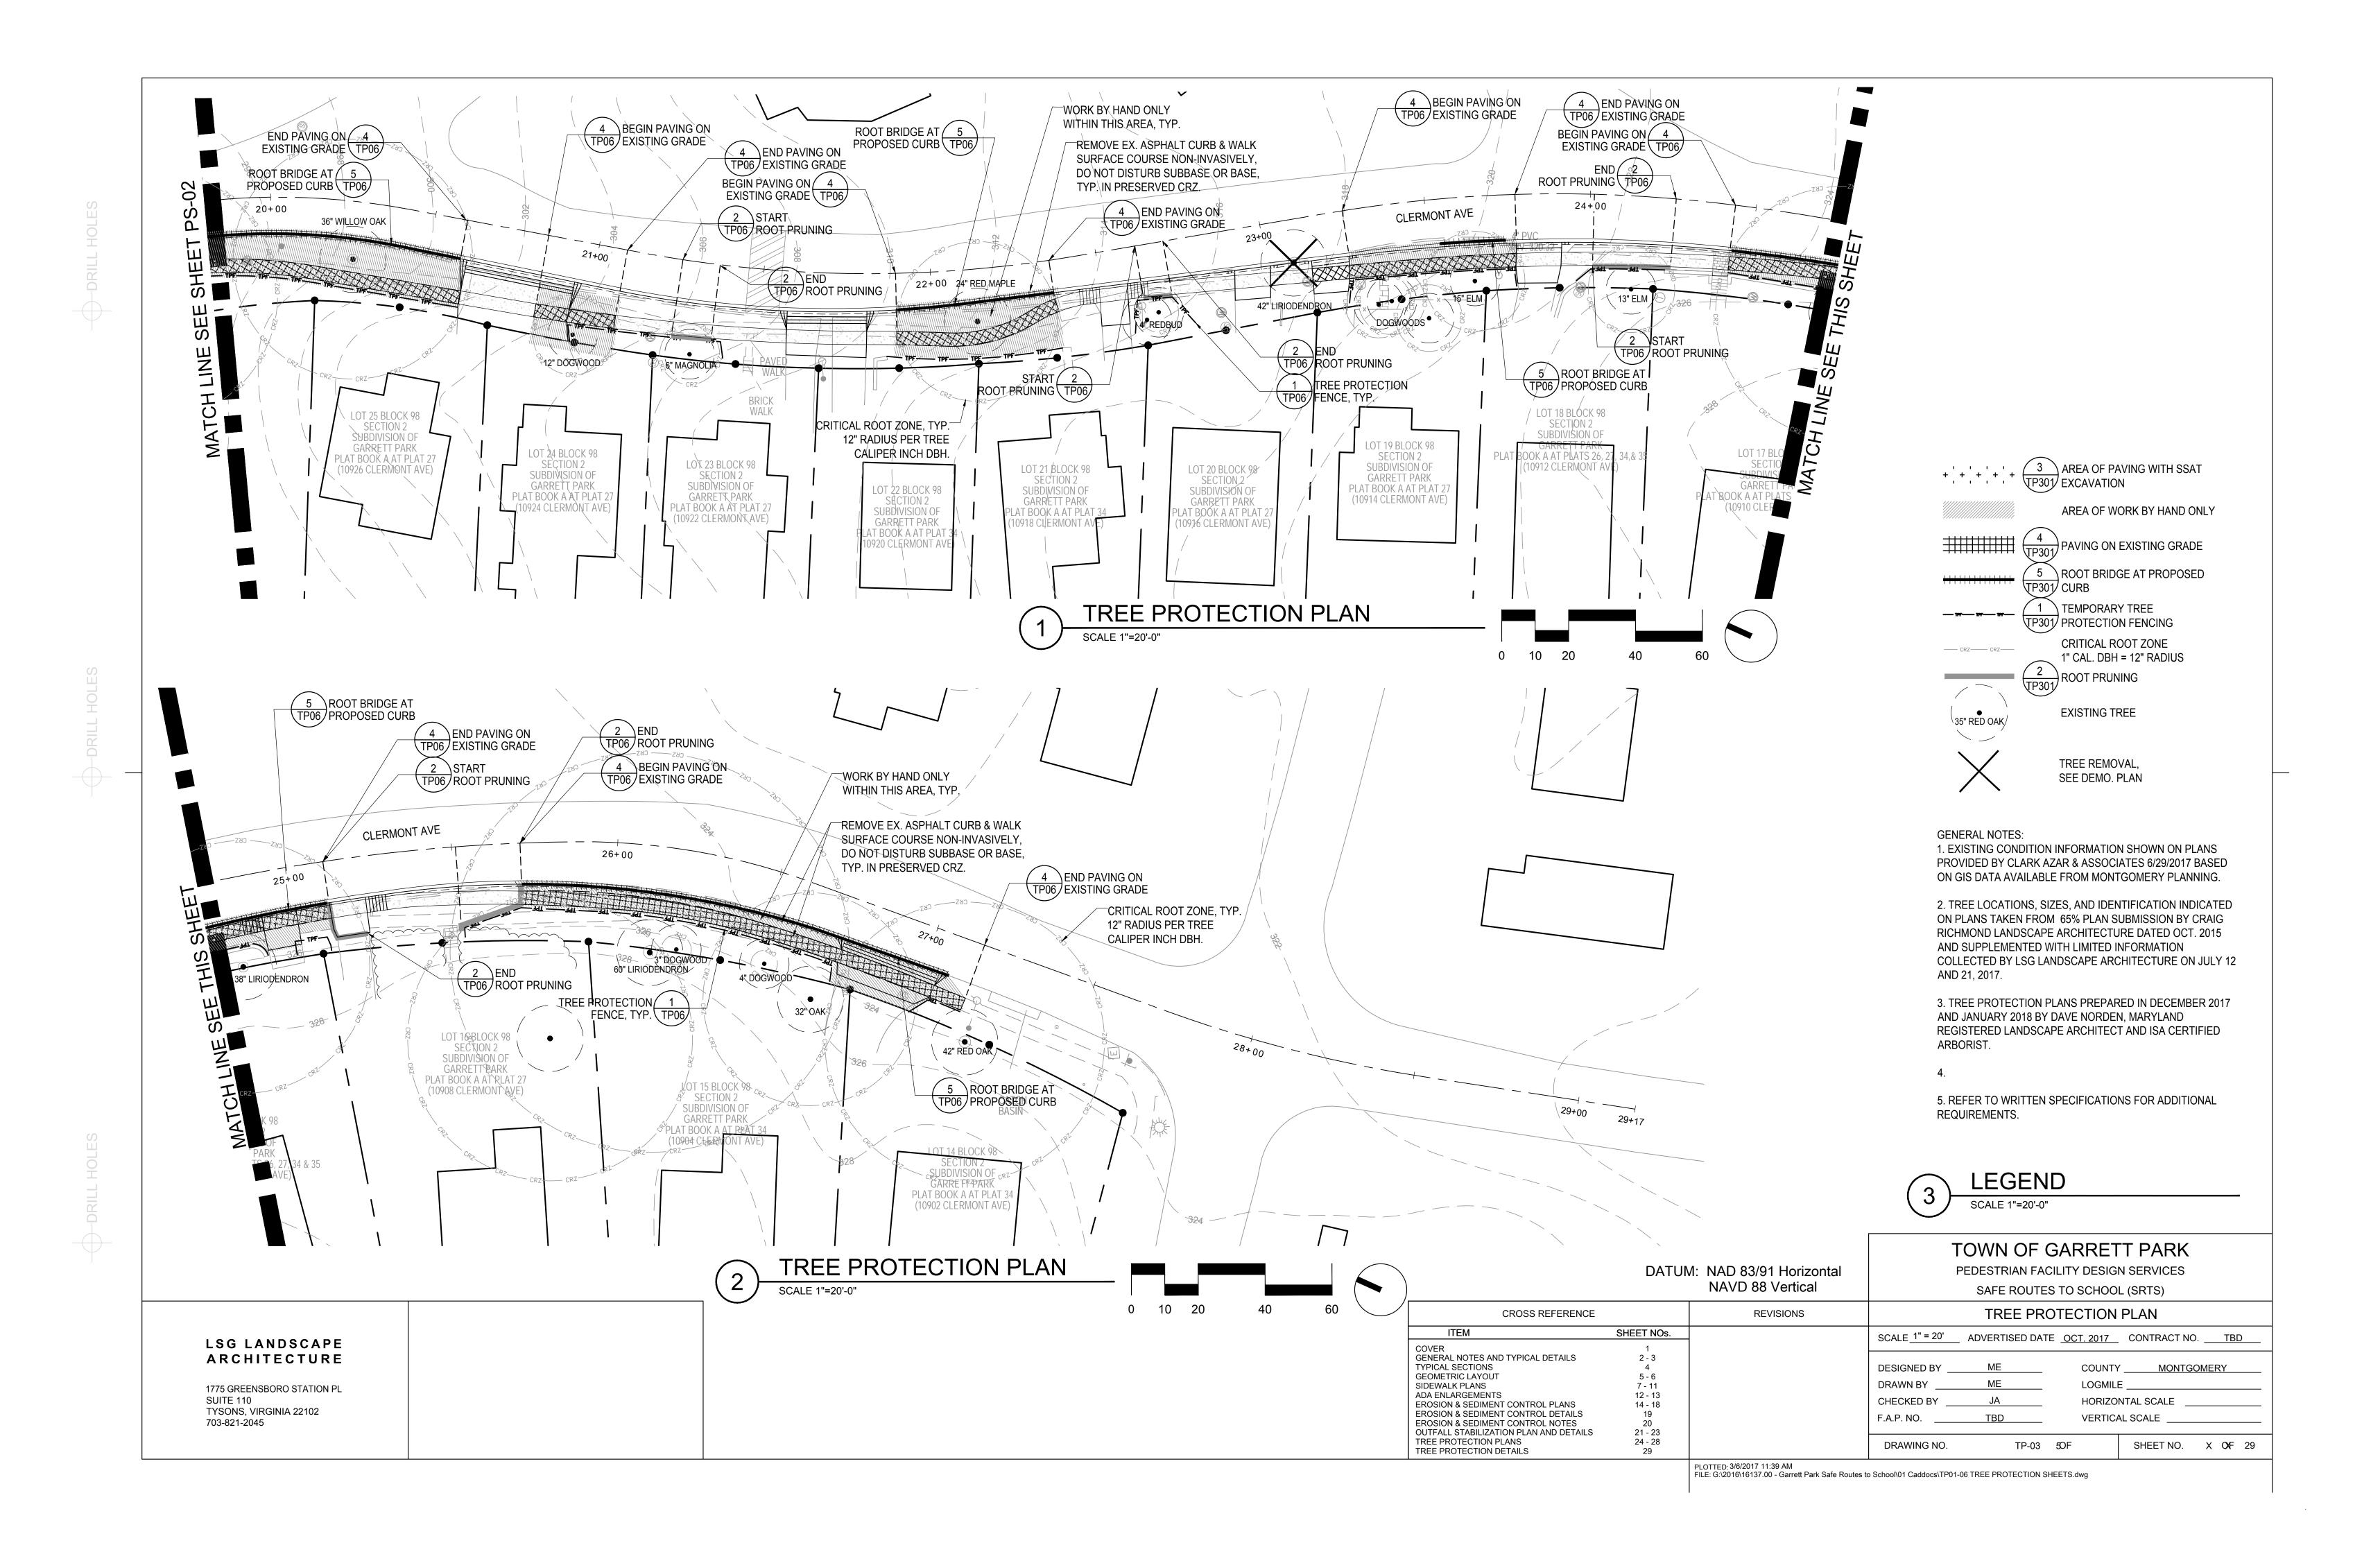

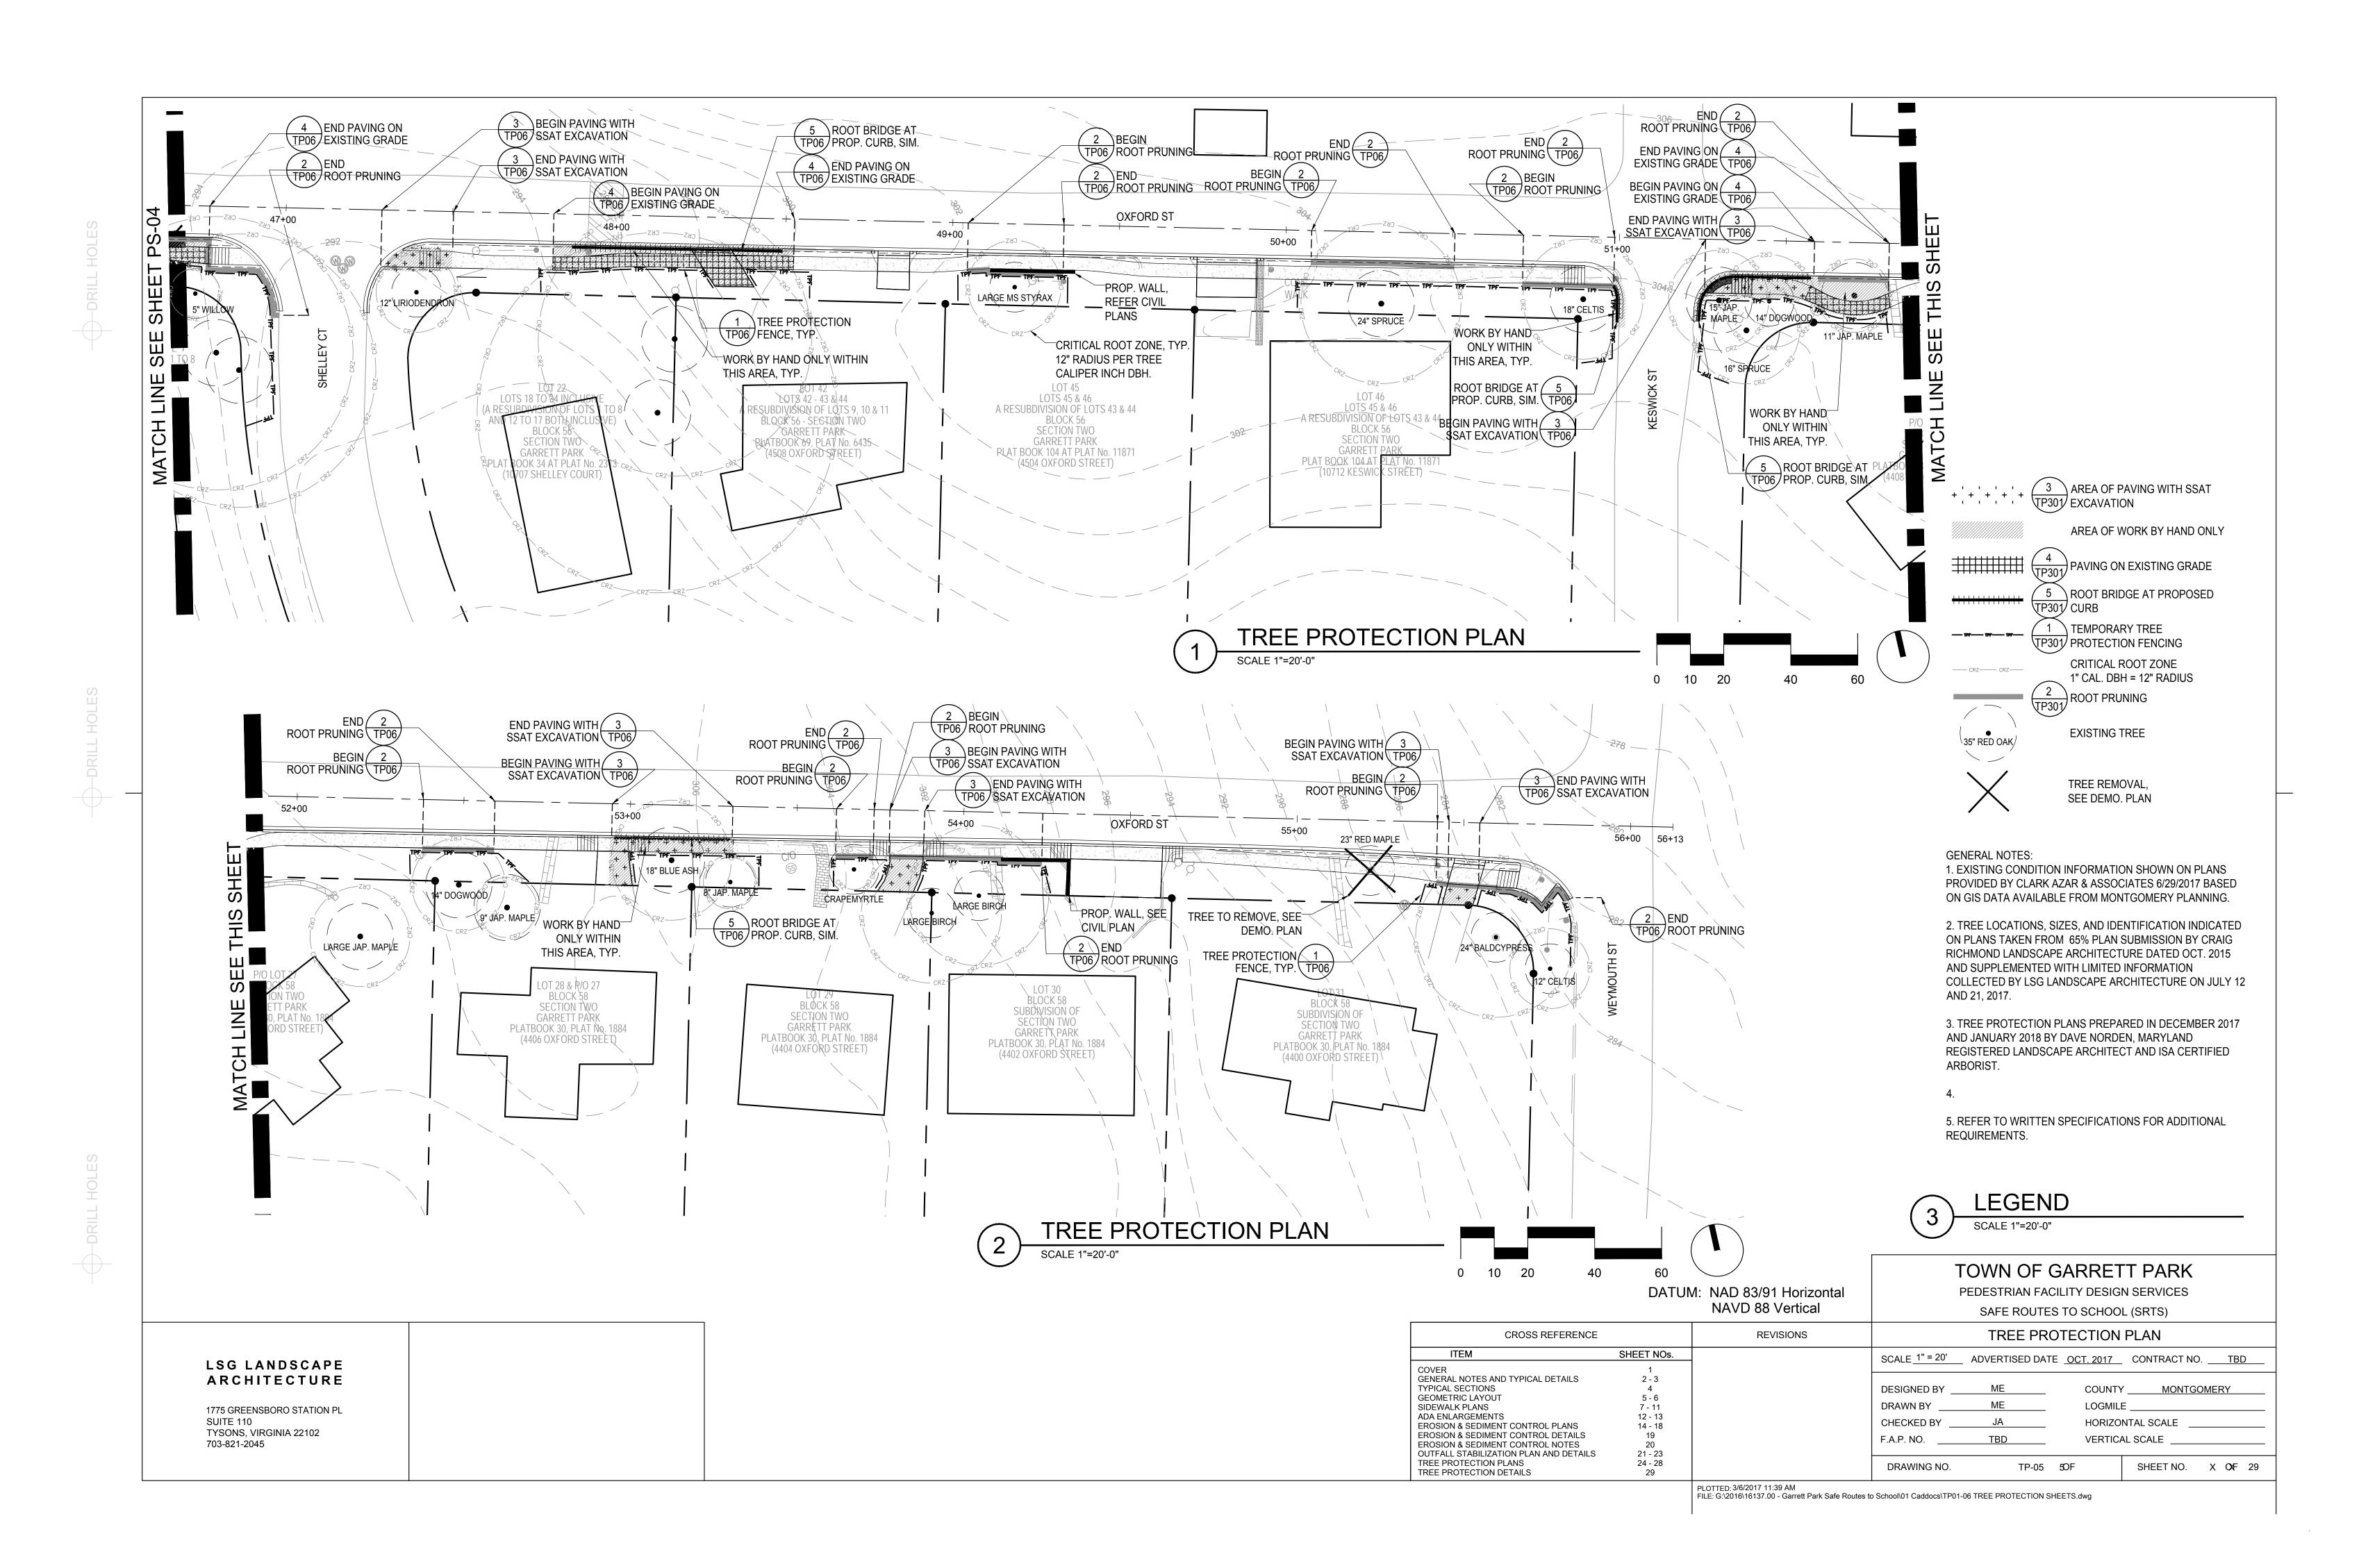







1. INSTALL PROTECTION FENCING AT LOCATIONS INDICATED ON TP PLANS PRIOR TO STORAGE OF MATERIALS AND START OF DEMOLITION AND OTHER WORK FOR EACH SECTION THAT IS TO BEGIN. FENCING MAY BE REMOVED UPON WRITTEN APPROVAL BY OWNER'S REPRESENTATIVE THAT THE RESPECTIVE SECTION HAS BEEN COMPLETED AND ACCEPTED.

- 12" LENGTH FLAGGING TAPE; 4'-0" O.C.;

13/16" WIDE; FLUORESCENT LIME GREEN.

TREE PROTECTION SIGN PER ------

2"x4" WELDED WIRE FABRIC, 12 GA.; ATTACH TO POST W/ 3/4" WIRE STAPLES

GALVANIZED U-CHANNEL POST

6" DEPTH SHREDDED HARDWOOD

MULCH INSIDE FENCED ENCLOSURE

STANDARD; 25'-0" O.C. MAX.


@ 18" O.C.

2x4 WOOD OR 2#/FT.

2. REFER TO WRITTEN SPECIFICATIONS FOR ADDITIONAL REQUIREMENTS.

8'-0" MAX.

TREE PROTECTION FENCE

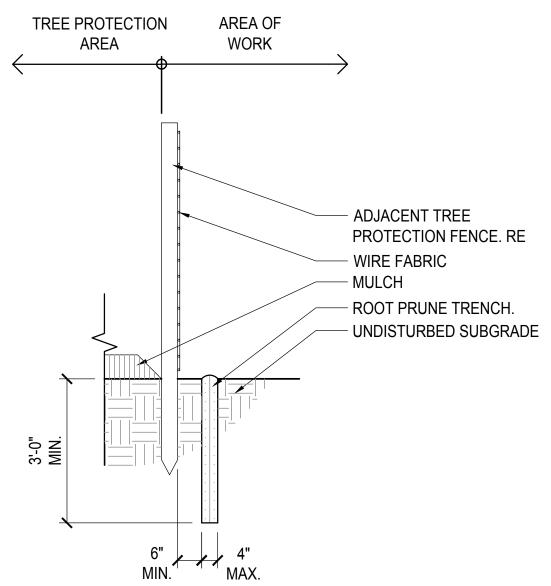


1. INSTALL ROOT PRUNE TRENCH AND PRUNE BY WHEEL SAW OR SSAT AIRSPADE & HAND PRUNING ONLY. BACKFILL W/ TOPSOIL W/IN (1) HOUR.

ROOT PRUNE TRENCH - SECTION

PROPOSED CONC. SIDEWALK, SIM. REFER TO CIVIL DETAILS GEOGRID 1'-0" SHOULDER COMPACTED BACKFILL @ 2%, TYP. ROOT AERATION MATTING. VENT AT TOE OF SLOPE (TYP.) 12" MINIMUM TURF NAILS W/ 1½"Ø WASHERS, STAGGERED 36" O.C. - EXISTING TREE ROOTS FOR ALL OTHER WORK WITHIN TREE PROTECTION ZONES, REFER TO SPECIFICATIONS. EXCAVATE BY SUPERSONIC AIR TOOL TO ROOT REFUSAL DEPTH.

SANDWICH ROOT AERATION MATTING BETWEEN 2 LAYERS OF CLASS F SILT FABRIC (NOT SHOWN). PAVING WITH SSAT EXCAVATION

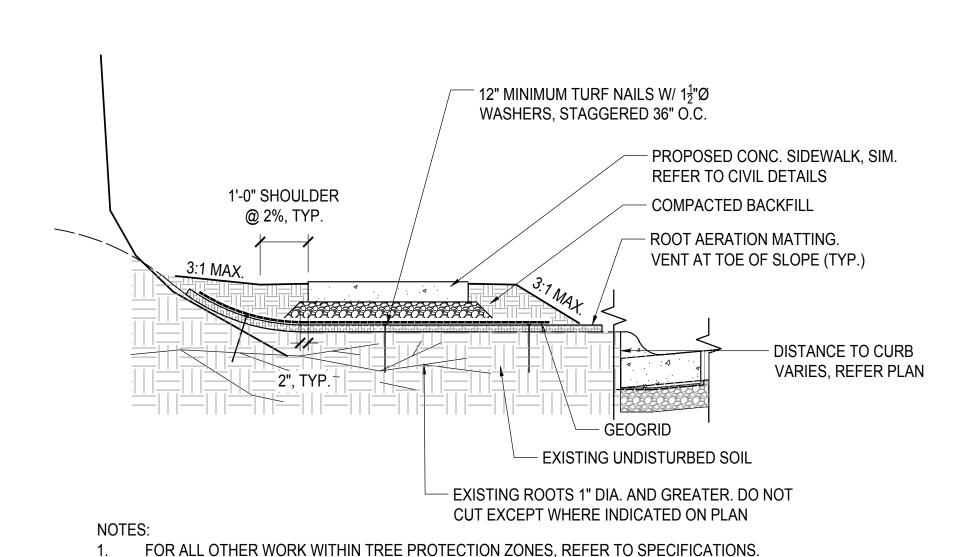


SANDWICH ROOT AERATION MATTING BETWEEN 2 LAYERS OF CLASS F SILT FABRIC (NOT SHOWN).

ROOT BRIDGE ON EXISTING GRADE

- PROPOSED CONDITION BEYOND VARIES PER PLAN - PAVEMENT REMOVAL OVERDIG EXTENT - PROPOSED CONC. CURB AND GUTTER, SIM. - REMOVE EX. ASPHALT PAVING BY NON-INVASIVE MEANS WHERE INDICATED ON TP DRAWINGS GEOGRID AND CLASS F SILT FABRIC, LAY ON UNDISTURBED ROAD SUBBASE UNDISTURBED ROAD SUBBASE - EXISTING UNDISTURBED SOIL - IF ENCOUNTERED, EXCAVATE SOIL CAREFULLY VIA SSAT BACK TO ALLOW DEFLECTION OF ROOTS 1" DIA. AND GREATER BELOW PR. CURBING. PIN ROOT WITH 12" TURF NAILS AT 36" O.C. - EXISTING ROOTS 1" DIA. AND GREATER. DO NOT CUT EXCEPT WHERE INDICATED ON PLAN

ROOT BRIDGE AT PROPOSED CURB

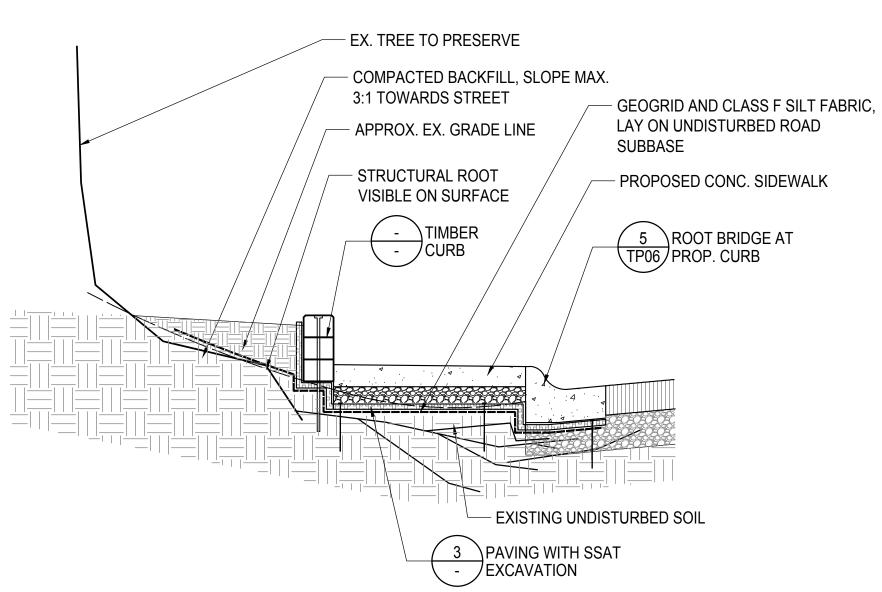

SECTION

LSG LANDSCAPE ARCHITECTURE

1775 GREENSBORO STATION PL SUITE 110 TYSONS, VIRGINIA 22102 703-821-2045

DATUM: NAD 83/91 Horizontal NAVD 88 Vertical

TOWN OF GARRETT PARK PEDESTRIAN FACILITY DESIGN SERVICES SAFE ROUTES TO SCHOOL (SRTS)

CROSS REFERENCE REVISIONS ITEM SHEET NOs. ADVERTISED DATE OCT. 2017 CONTRACT NO. ____TBD GENERAL NOTES AND TYPICAL DETAILS TYPICAL SECTIONS 2 - 3 COUNTY MONTGOMERY 5 - 6 7 - 11 12 - 13 GEOMETRIC LAYOUT SIDEWALK PLANS ADA ENLARGEMENTS LOGMILE HORIZONTAL SCALE **EROSION & SEDIMENT CONTROL PLANS** 14 - 18 **EROSION & SEDIMENT CONTROL DETAILS** 19 F.A.P. NO. VERTICAL SCALE _ **EROSION & SEDIMENT CONTROL NOTES** 20 21 - 23 24 - 28 OUTFALL STABILIZATION PLAN AND DETAILS TREE PROTECTION PLANS DRAWING NO. TP-06 OF 6 SHEET NO. X OF 29 TREE PROTECTION DETAILS

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